

INDEX OF SHEETS

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	26	DETAILS SIGNS
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	8	557+00 583+00
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	40	1325+00 1351+00
	41	1349+00 1375+00
	42	1373+00 1399+00
	43	1397+00 1423+00
	44	1421+00 1447+00
	45	1445+00 1471+00
	46	1469+00 1495+00
	47	1493+00 1519+00
	48	1517+00 1543+00
	49	1541+00 1567+00
	50	1565+00 1591+00
	51	1589+00 1615+00
	52	1613+00 1639+00
	53	1637+00 1663+00
	54	1661+00 1687+00
	55	1685+00 1711+00
	56	1709+00 1735+00
	57	1733+00 1759+00
	58	1757+00 1783+00
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	68	1991+00 2017+00
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	72	2087+00 2113+00
	73	2111+00 2137+00
	74	2129+00 2155+00
	75	2153+00 2179+00
	76	2177+00 2203+00
	77	2201+00 2227+00
	78	2219+00 2245+00
	79	2243+00 2269+00
	80	2267+00 2293+00
	81	2291+00 2317+00
	82	2315+00 2341+00
	83	2339+00 2365+00
	84	2363+00 2389+00
	85	2387+00 2413+00
	86	2411+00 2437+00
	87	2429+00 2455+00
	88	2453+00 2479+00
	89	2477+00 2503+00
	90	2501+00 2527+00
	91	2519+00 2545+00
	92	2543+00 2569+00
	93	2567+00 2593+00
	94	2591+00 2617+00
	95	2615+00 2641+00
	96	2639+00 2665+00
	97	2663+00 2689+00
	98	2687+00 2713+00
	99	2711+00 2737+00
	100	2729+00 2755+00

STATE OF WYOMING
 STATE HIGHWAY DEPARTMENT
 PLAN AND PROFILE OF PROPOSED
 STATE HIGHWAY
 FEDERAL AID PROJECT
 ALBANY COUNTY
 LARAMIE-TIE SIDING ROAD

PLANS AND PROFILES PROPOSED IN THE FOLLOWING SHEETS:
 PLANS NO. 7735 7736
 BUREAU OF PUBLIC ROADS


PLAN: 1 IN. = 200 FT.
 PROFILE: HORIZ. 1 IN. = 200 FT. VERT. 1 IN. = 20 FT.
 LAYOUT: 1 IN. = 100 FT.

INDEX OF STRUCTURE SHEETS.

SHEET No.	1	BRIDGE 5700 S - Sta 570+00
	2	BRIDGE 5700 S - Sta 570+00
	3	BRIDGE 5700 S - Sta 570+00
	4	BRIDGE 5700 S - Sta 570+00
	5	BRIDGE 5700 S - Sta 570+00

CONVENTIONAL SIGNS

TOWNSHIP LINE	RAILROAD
SECTION LINE	IRRIGATION NOTCH
INTERIOR SEC. LINE	CULVERT
BOUNDARY LINE	BRIDGE
POLYLINE	TOWN
RIGHT OF WAY	POST OFFICE
SURVEY LINE	STATE LAND
TRAIL WOOD MARK	GRADE ELEVATION





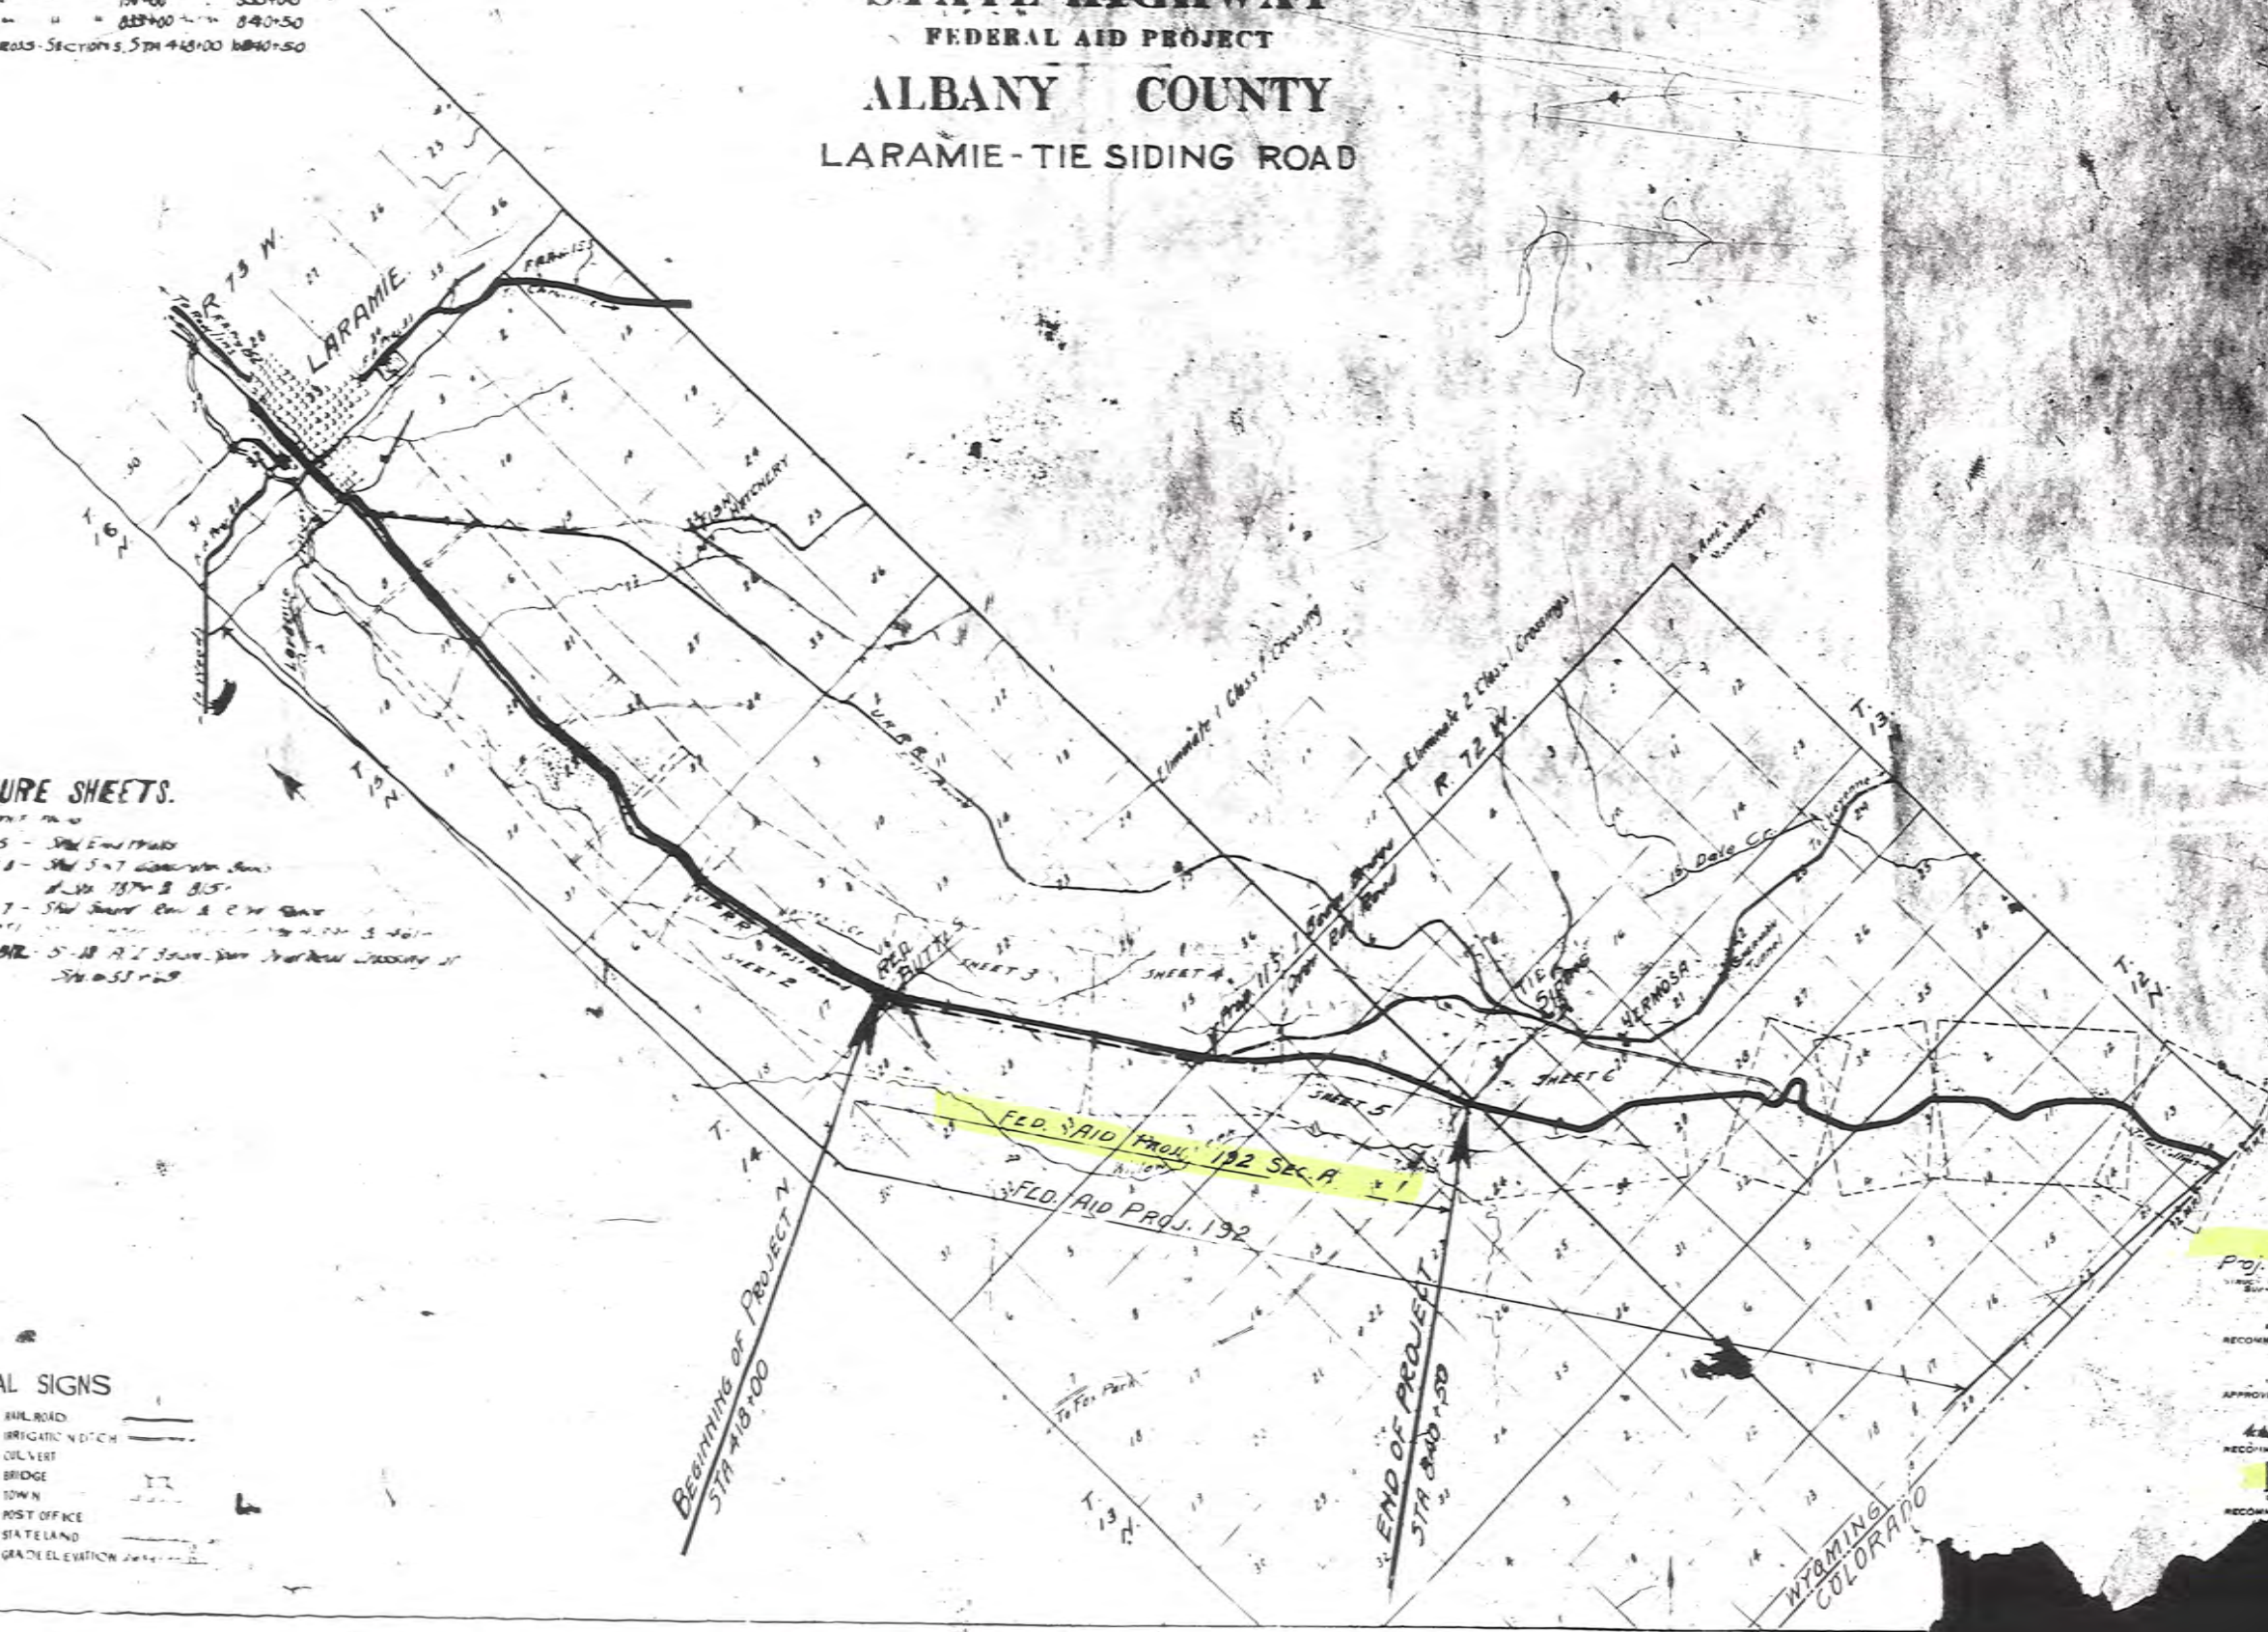


Proj. 192 Sec. A.
 STATE HIGHWAY ENGINEER
 APPROVED
 STATE ENGINEER
 RECOMMENDED FOR APPROVAL
 DISTRICT ENGINEER

WYOMING
 COLORADO

FINAL SURFACING & HAUL 41-9-A-F-E

Station to Station	DIST. FT. BY PAVED	TONS PER SQ. YD.	AV. DEPTH INCHES	TONS SURFACING	HAUL MILES
PIT NO 1-350' East of Station 603+00					
417+94	418	6.0	0.25	2.34	16
418	450	3200.0	0.50	5.46	1600.0
450	461	1100.0	0.25	2.34	275.0
461	473	1200.0	0.50	5.46	600.0
473	491	1800.0	0.25	2.34	450.0
491	496+07	507.0	0.50	5.46	253.5
496+07	539+25.2	4318.2	0.25	2.34	1079.5
539+25.2	603+00	637.9			
Subtotal PIT NO 1	12131.2			4252.6	1024.8
PIT NO 2-575' East of Station 603+00					
603	701+95.1	9958.6			
701+95.1	708	604.9	0.25	2.34	151.2
708	740+22.2	3222.2			
740+22.2	829	7409.6	0.25	2.34	1852.4
Subtotal PIT NO 2	27570.1			3622.4	2165.3
TOTALS	39701.3			7875.0	2090.1

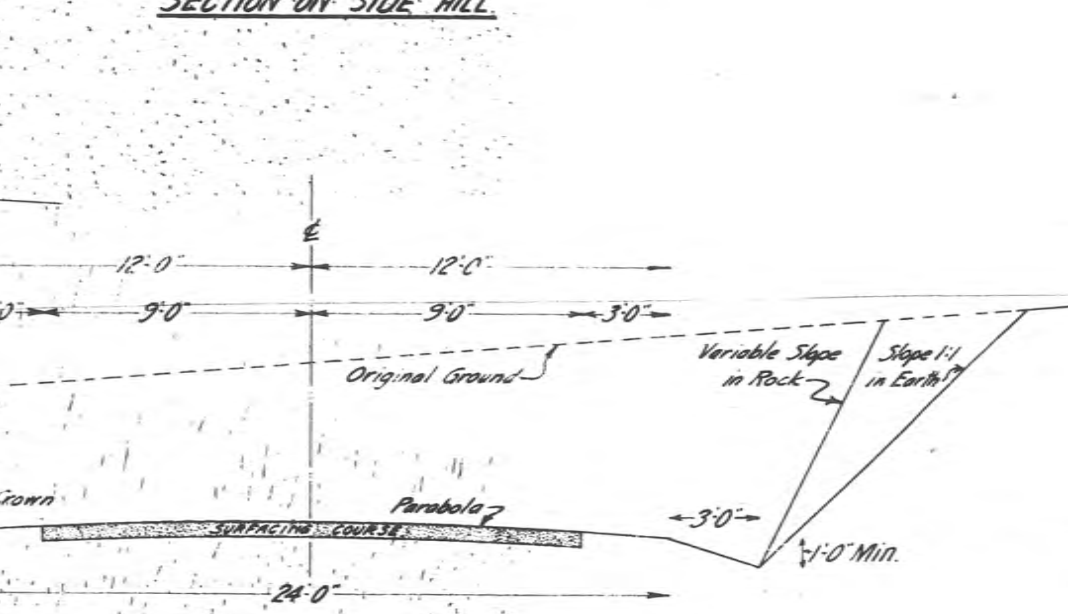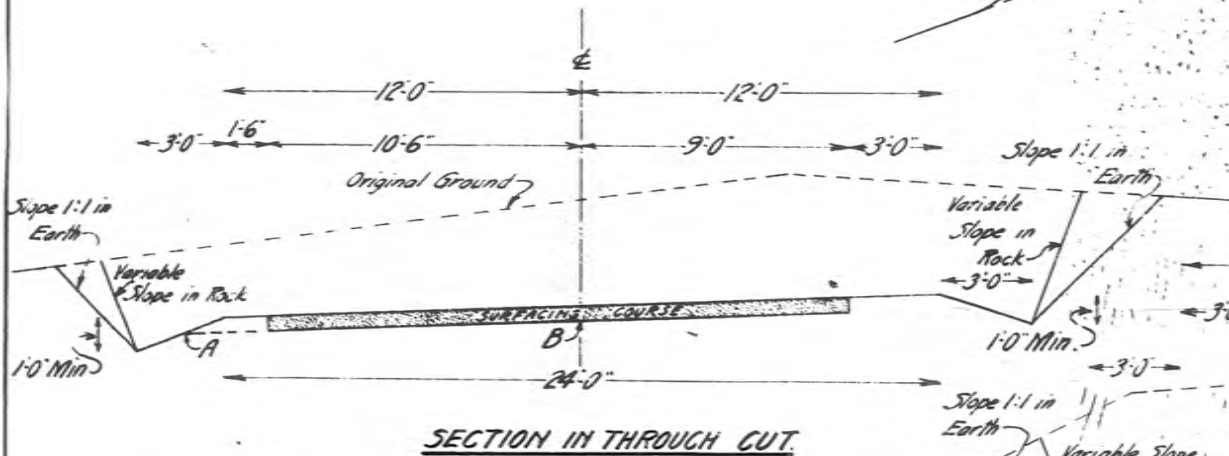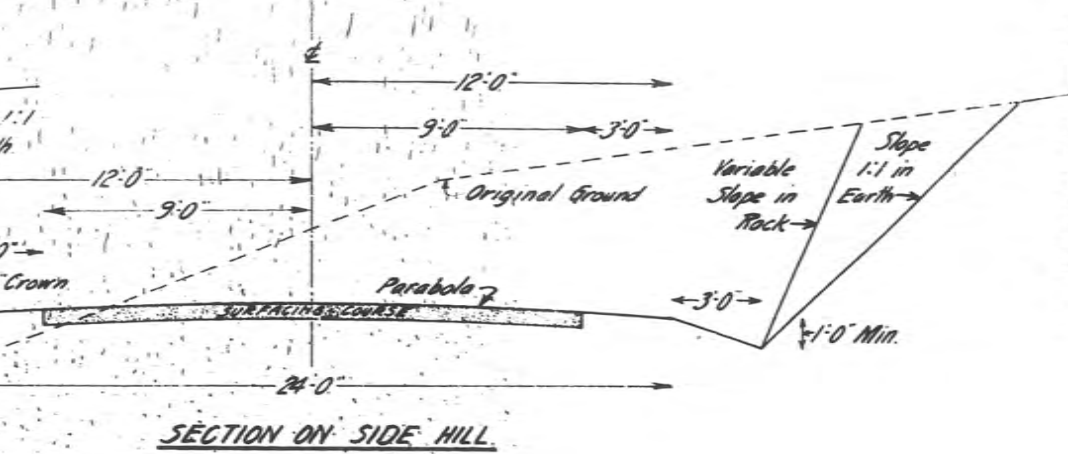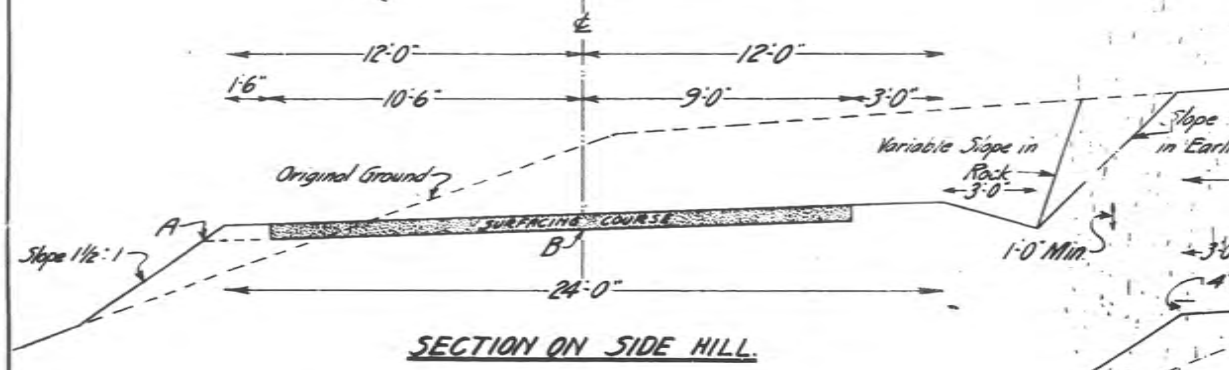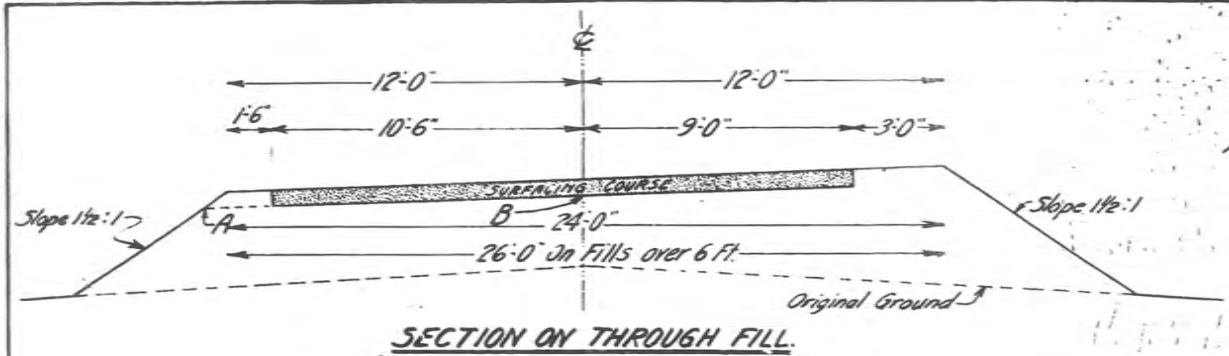


TYPICAL SECTIONS ON CURVES.

NOTE:— On Curves on grades of 15% and over, Profile Grade to be carried at "B". On Curves on grades of less than 15% Profile Grade to be carried at "A". Superlevation and Extra Width to Taper from zero at points 120 ft on the Tangent from the P.C. and the P.T. to the full Extra Width and Superlevation at the P.C. and the P.T.
Slope 0.0105 ft. per foot per degree of Curve
Maximum Slope 0.084 ft. per foot.

Dotted line Shows Section in Daylight Cut, Slope 1/8" per foot.

Where Slope of Ground or Height of Fill makes 8 Foot Berm impractical, Engineer may reduce width of Berm to not less than 4 Feet.

Barron Pit. Berm to be not less than 8 Ft.

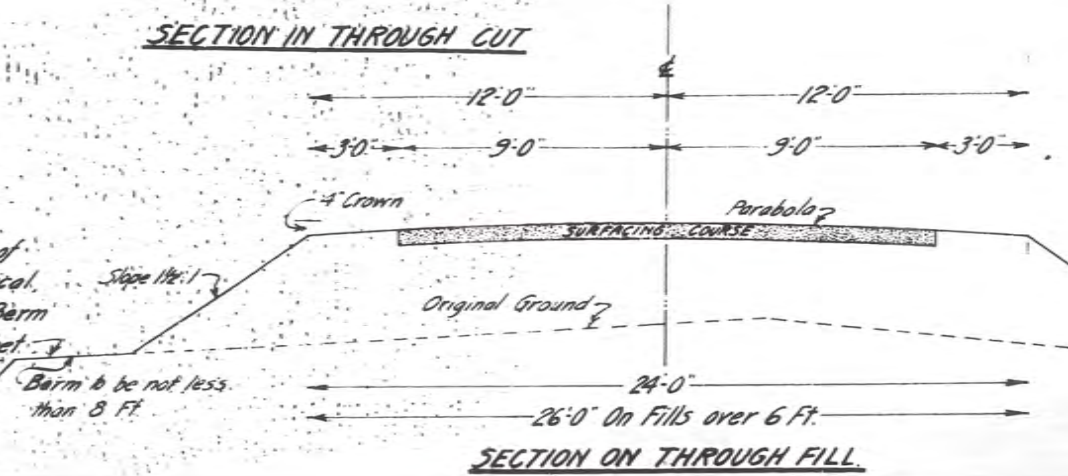

STATE OF WYOMING
STATE HIGHWAY DEPARTMENT.
TYPICAL SECTIONS OF ROADWAY.

APPROVED *[Signature]* 7-10-28
STATE HIGHWAY SUPERINTENDENT.

FINAL SURFACING & HAUL AI-9-AFE

Station to Station	DIST. FT.	TONS PER FOOT	PIE THICKNESS	TONS SURFACING	TONS HAUL	MILES
Pit No 1 - 350' East of Station 603+00						
417+94	418	6.0	0.25	2.46	16	3.5706
418	450	3200.0	0.50	5.16	1600.0	3.2670
450	461	1100.0	0.25	2.46	275.0	2.8598
461	473	7200.0	0.50	5.16	600.0	2.6420
473	491	1800.0	0.25	2.46	450.0	2.3579
491	496+107	507.0	0.50	5.16	253.5	2.1395
496+107	539+25.2	4318.2	0.25	2.46	1079.5	1.6825
539+25.2	603+00	6374.3				
Subtotal Pit No 1	12131.2			4252.6		11024.2
Pit No 2 - 575' East of Station 603+00						
603	701+95.1	9958.6				
701+95.1	708	604.9	0.25	2.46	151.2	2.0523
708	740+22.2	3222.2				
740+22.2	829	7409.6	0.25	2.46	1852.4	3.4215
Subtotal Pit No 2	27570.1			3622.4		2165.3
TOTALS	39701.3			7882.0		20189.5

Selected Material Surfacing -


1928

10-23-28


J.W.J.

STATE OF WYOMING
STATE HIGHWAY DEPARTMENT
TYPICAL SECTIONS OF ROADWAY

APPROVED *J. J. [Signature]* 7-10-28
STATE HIGHWAY SUPERINTENDENT

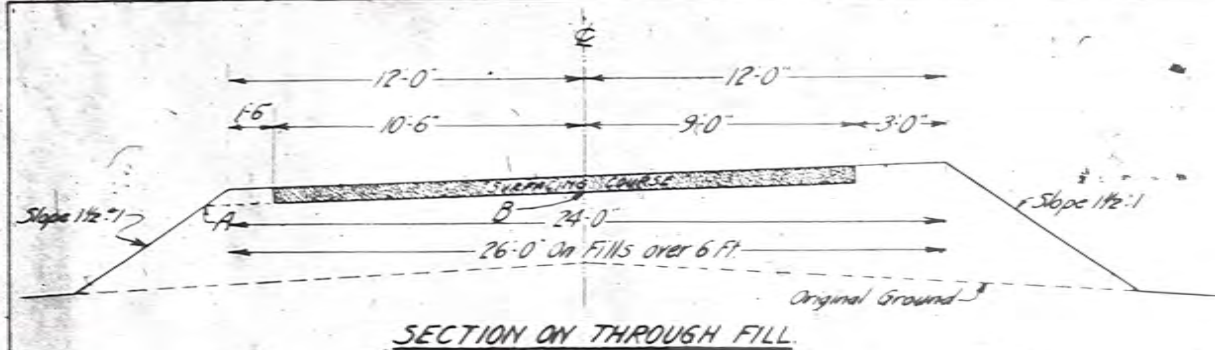


SECTION ON THROUGH FILL

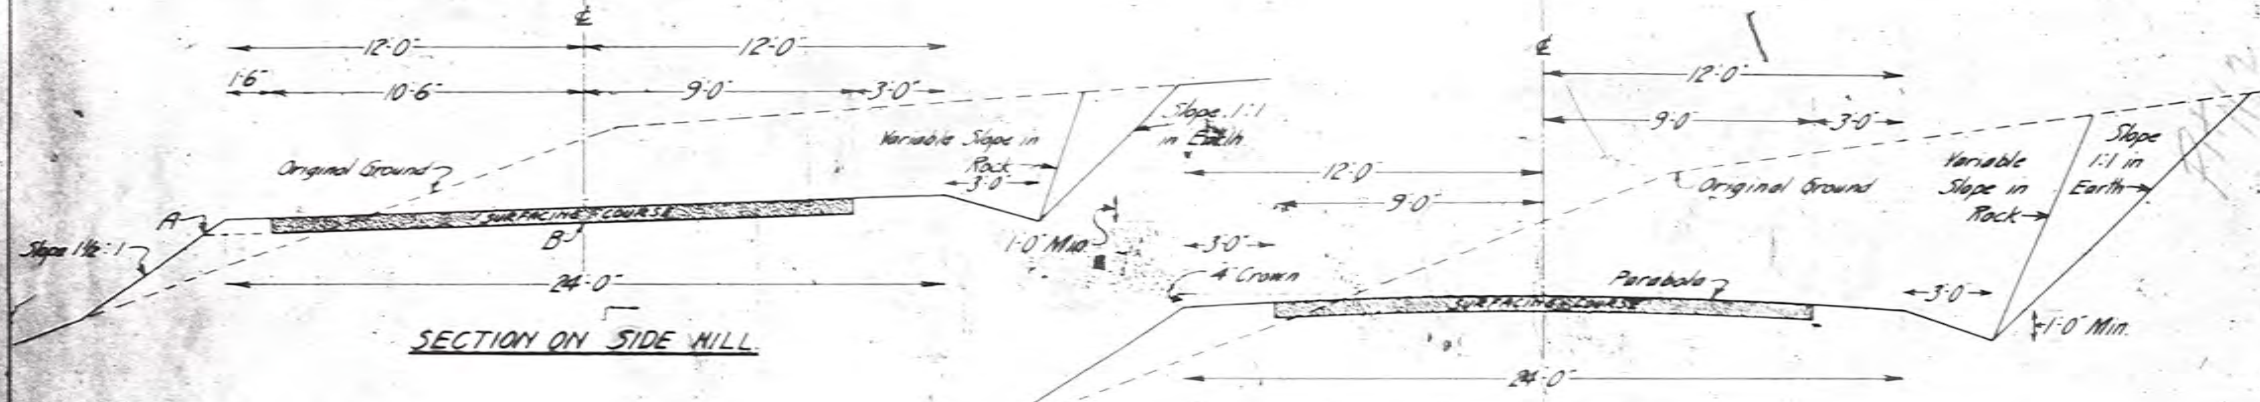

SECTION ON SIDE HILL

SECTION ON SIDE HILL

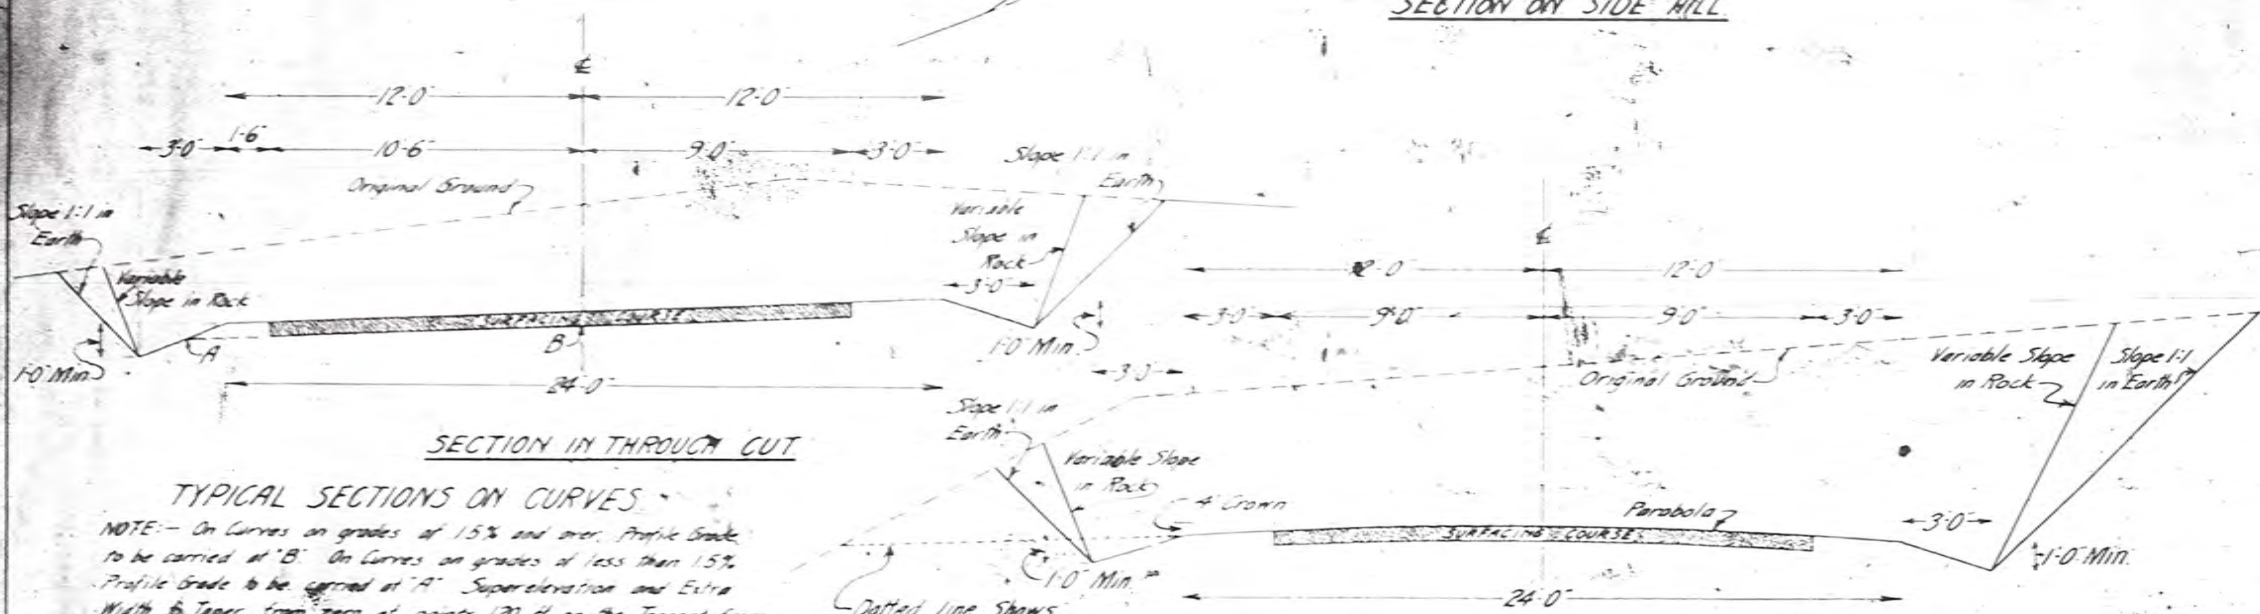

SECTION IN THROUGH CUT

SECTION IN THROUGH CUT


TYPICAL SECTIONS ON CURVES

NOTE: - On Curves on grades of 15% and over, Profile Grade to be carried at "B". On Curves on grades of less than 15%, Profile Grade to be carried at "A". Super-elevation and Extra Width to Taper from zero at points 120 ft. on the Tangent from the P.C. and the P.T. to the full Extra Width and Super-elevation at the P.C. and the P.T.
Slope 0.0025 ft. per foot per degree of Curve
Maximum Slope 0.084 ft. per foot


Dotted line shows Section in Daylight Cut.
Slope 1/8" per foot

Where Slope of Ground or Height of Fill makes 8 Foot Berm impractical, Engineer may reduce width of Berm to not less than 4 Feet.


Borrow Pit
Berm to be not less than 8 Ft.

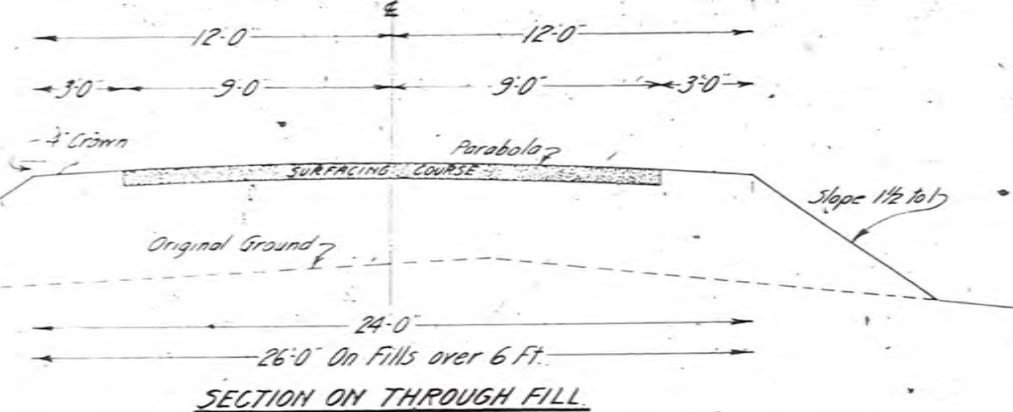

SECTION ON THROUGH FILL

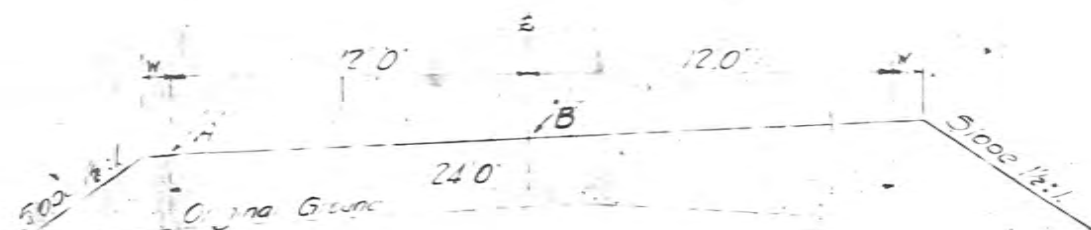


SECTION ON THROUGH FILL

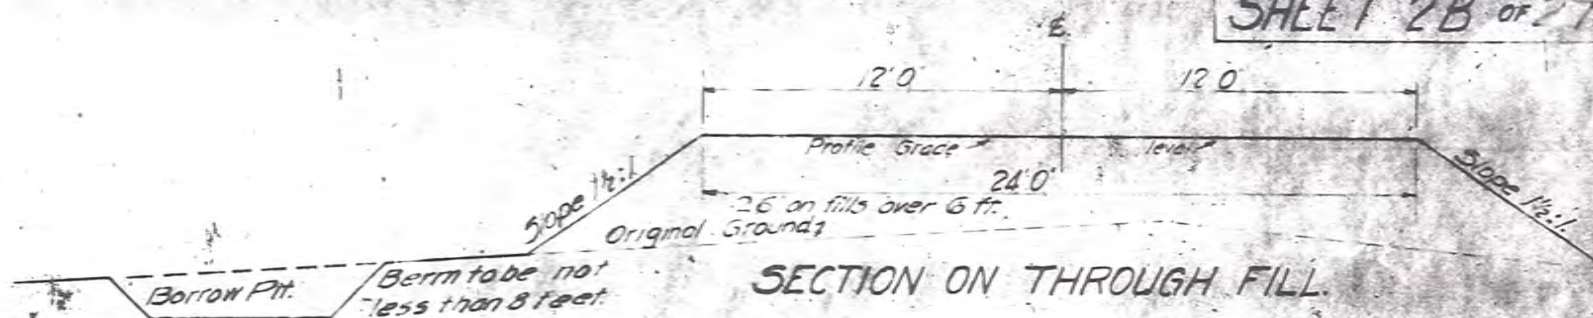


SECTION ON THROUGH FILL

Note: Where slope of ground or height of fill makes eight foot berm impractical, Engineer may reduce width of berm to not less than four feet.

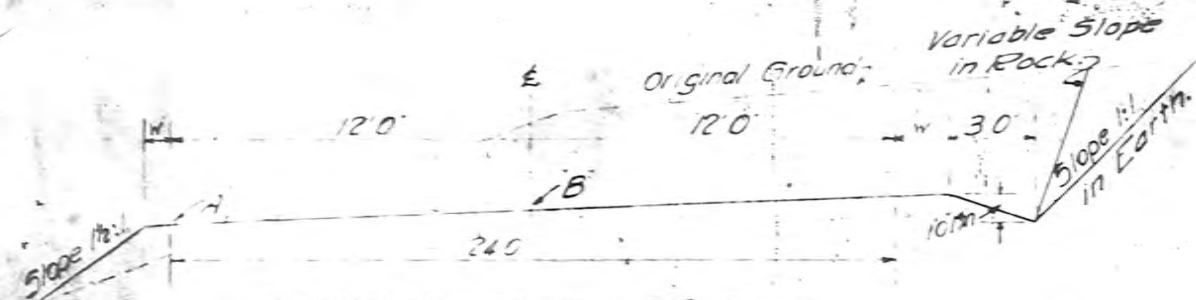


SECTION ON SIDE HILL

Note: w = extra width to allow for shoulders on future surfacing = 9 in fill; 18 in cut.

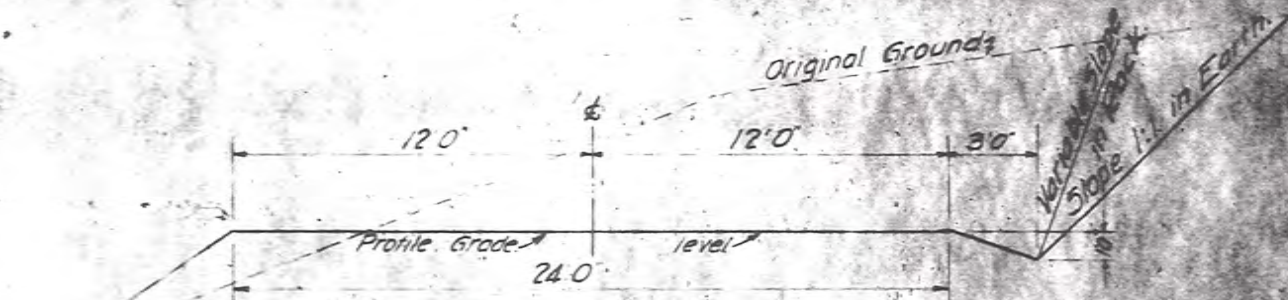


SECTION ON SIDE HILL

Note: Where grading is not immediately followed by surfacing, 3 1/2" crown to be placed by maintenance force from material bladed in from shoulders or ditches.

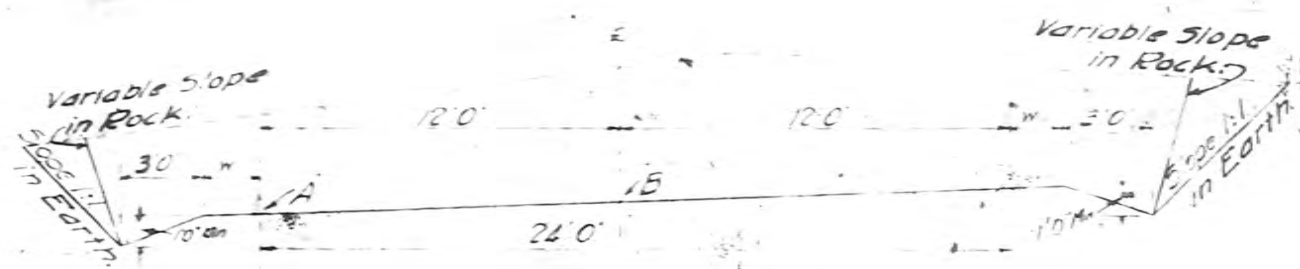

SECTION IN THROUGH CUT

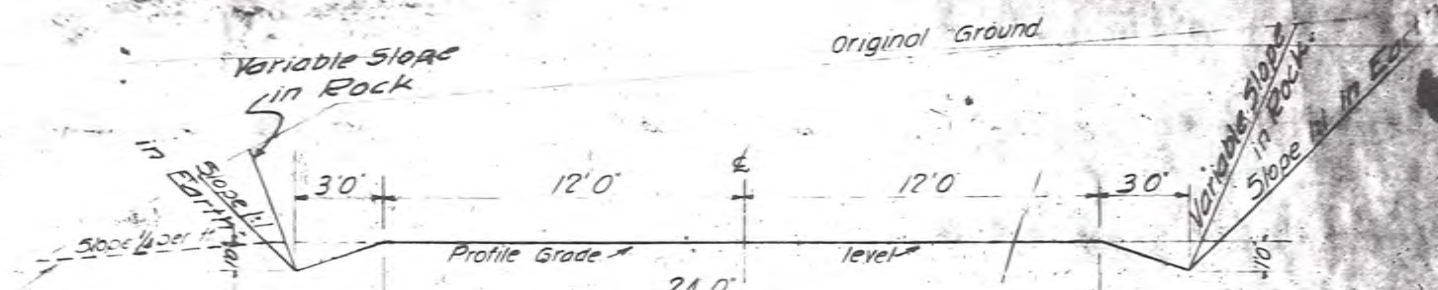

SECTION IN THROUGH CUT

TYPICAL SECTIONS ON CURVES

Note: On Curves on grades of 1.5% and over, profile grade to be carried at 'B'. On curves on grades of less than 1.5% or a grade to be carried at 'A'. Super-elevation to taper from zero at points 60 ft on the tangent from the P.C. and P.T. to the full super-elevation at the P.C. and P.T. Slope 0.0105 ft. per ft. per degree of Curve. Maximum Slope 0.0840 ft. per ft.

TYPICAL SECTIONS OF ROADWAY

SHOWING COMPLETED ROADWAY UNDER 1ST PHASE OF 2 PHASE CONSTRUCTION

PROJ. No. 192 A
INDEX OF SHEETS

SHEET No.	TITLE PAGE
2B	TYPICAL CROSS-SECTION OF HIGHWAY
2C	DETOUR SIGNS
2	PLAN AND PROFILE STA. 418+00 TO STA. 442+00
3	" " " " " " 441+00 " " 568+00
4	" " " " " " 567+00 " " 693+00
5	" " " " " " 693+00 " " 757+00
5	" " " " " " 756+00 " " 833+00
6	" " " " " " 833+00 " " 840+50
7-27	Cross-Sections, STA. 418+00 to 840+50

PROJ. No. 192 B

SHEET No.	TITLE PAGE
2A	TYPICAL SECTIONS OF ROADWAY, DETOUR SIGNS, INCIDENTAL SMALL STRUCT.
2C	SUMMARY SHEET
2	PLAN AND PROFILE, STA. 840+50 to 883
3	" " " " " " 882 " 946
4	" " " " " " 945 " 1009
5	" " " " " " 1009 " 1072
6	" " " " " " 1071 " 1135
7	" " " " " " 1134 " 1178
8	" " " " " " 1197 " 1261
9	" " " " " " 1260 " 1324
10	" " " " " " 1322 " 1333+41.6
11 to 57	Cross-Sections

STATE OF WYOMING
STATE HIGHWAY DEPARTMENT
PLAN AND PROFILE OF PROPOSED
STATE HIGHWAY
FEDERAL AID PROJECT
ALBANY COUNTY
LARAMIE-FT. COLLINS
ROAD.

NOTE—SPEC. PL.

INDEX OF STRUCTURE SHEETS.

TO ACCOMPANY THIS FOLDER.


SHEET No.	DRWG. No.	STRUCTURE
1	3750.5	Std. End Walls
2	401 B.C.B.	Std. 5x7 Concrete Box at Sta. 787+ & 815+
3	3833.7	Std. Guard Rail & R/W Fence
4	433 P.T.1	Std. Timber Trestles at Sta. 433+ & 461+
5	433 B.12	5-27 Ft. I-Beam Span Overhead Crossing at 2 Sheets Sta. 653+68.

INDEX OF STRUCTURE SHEETS 192 B.

SHEET No.	DRWG. No.	STRUCTURE
1	3833.8	STD. WIRE CABLE GUARD FENCE.
2B		DETOUR SIGNS.
3	TA 3721.11	STD. 4x4 CONC. BOX CULVERT, STA. 1021+90.
4	401 B.C.B. & 3	STD. 5x7 CONC. BOX CULVERT, STA. 878+20.
5	5-102	STD. TREATED TIMBER TRESTLE, STA. 898+81-941+77 & 985+57.
6	1006	PROFILES AT BRIDGE SITES, STA. 898+81-941+77 & 985+57.

CONVENTIONAL SIGNS

TOWNSHIP LINE	RAILROAD	IRRIGATION DITCH
SECTION LINE	IRRIGATION DITCH	CULVERT
INTERIOR SEC. LINE	BRIDGE	TOWN
FENCE LINE	TOWN	POST OFFICE
POLE LINE	POST OFFICE	STATE LAND
RIGHT OF WAY	STATE LAND	GRADE ELEVATION
SURVEY LINE	GRADE ELEVATION	
TRAVELED WAY		

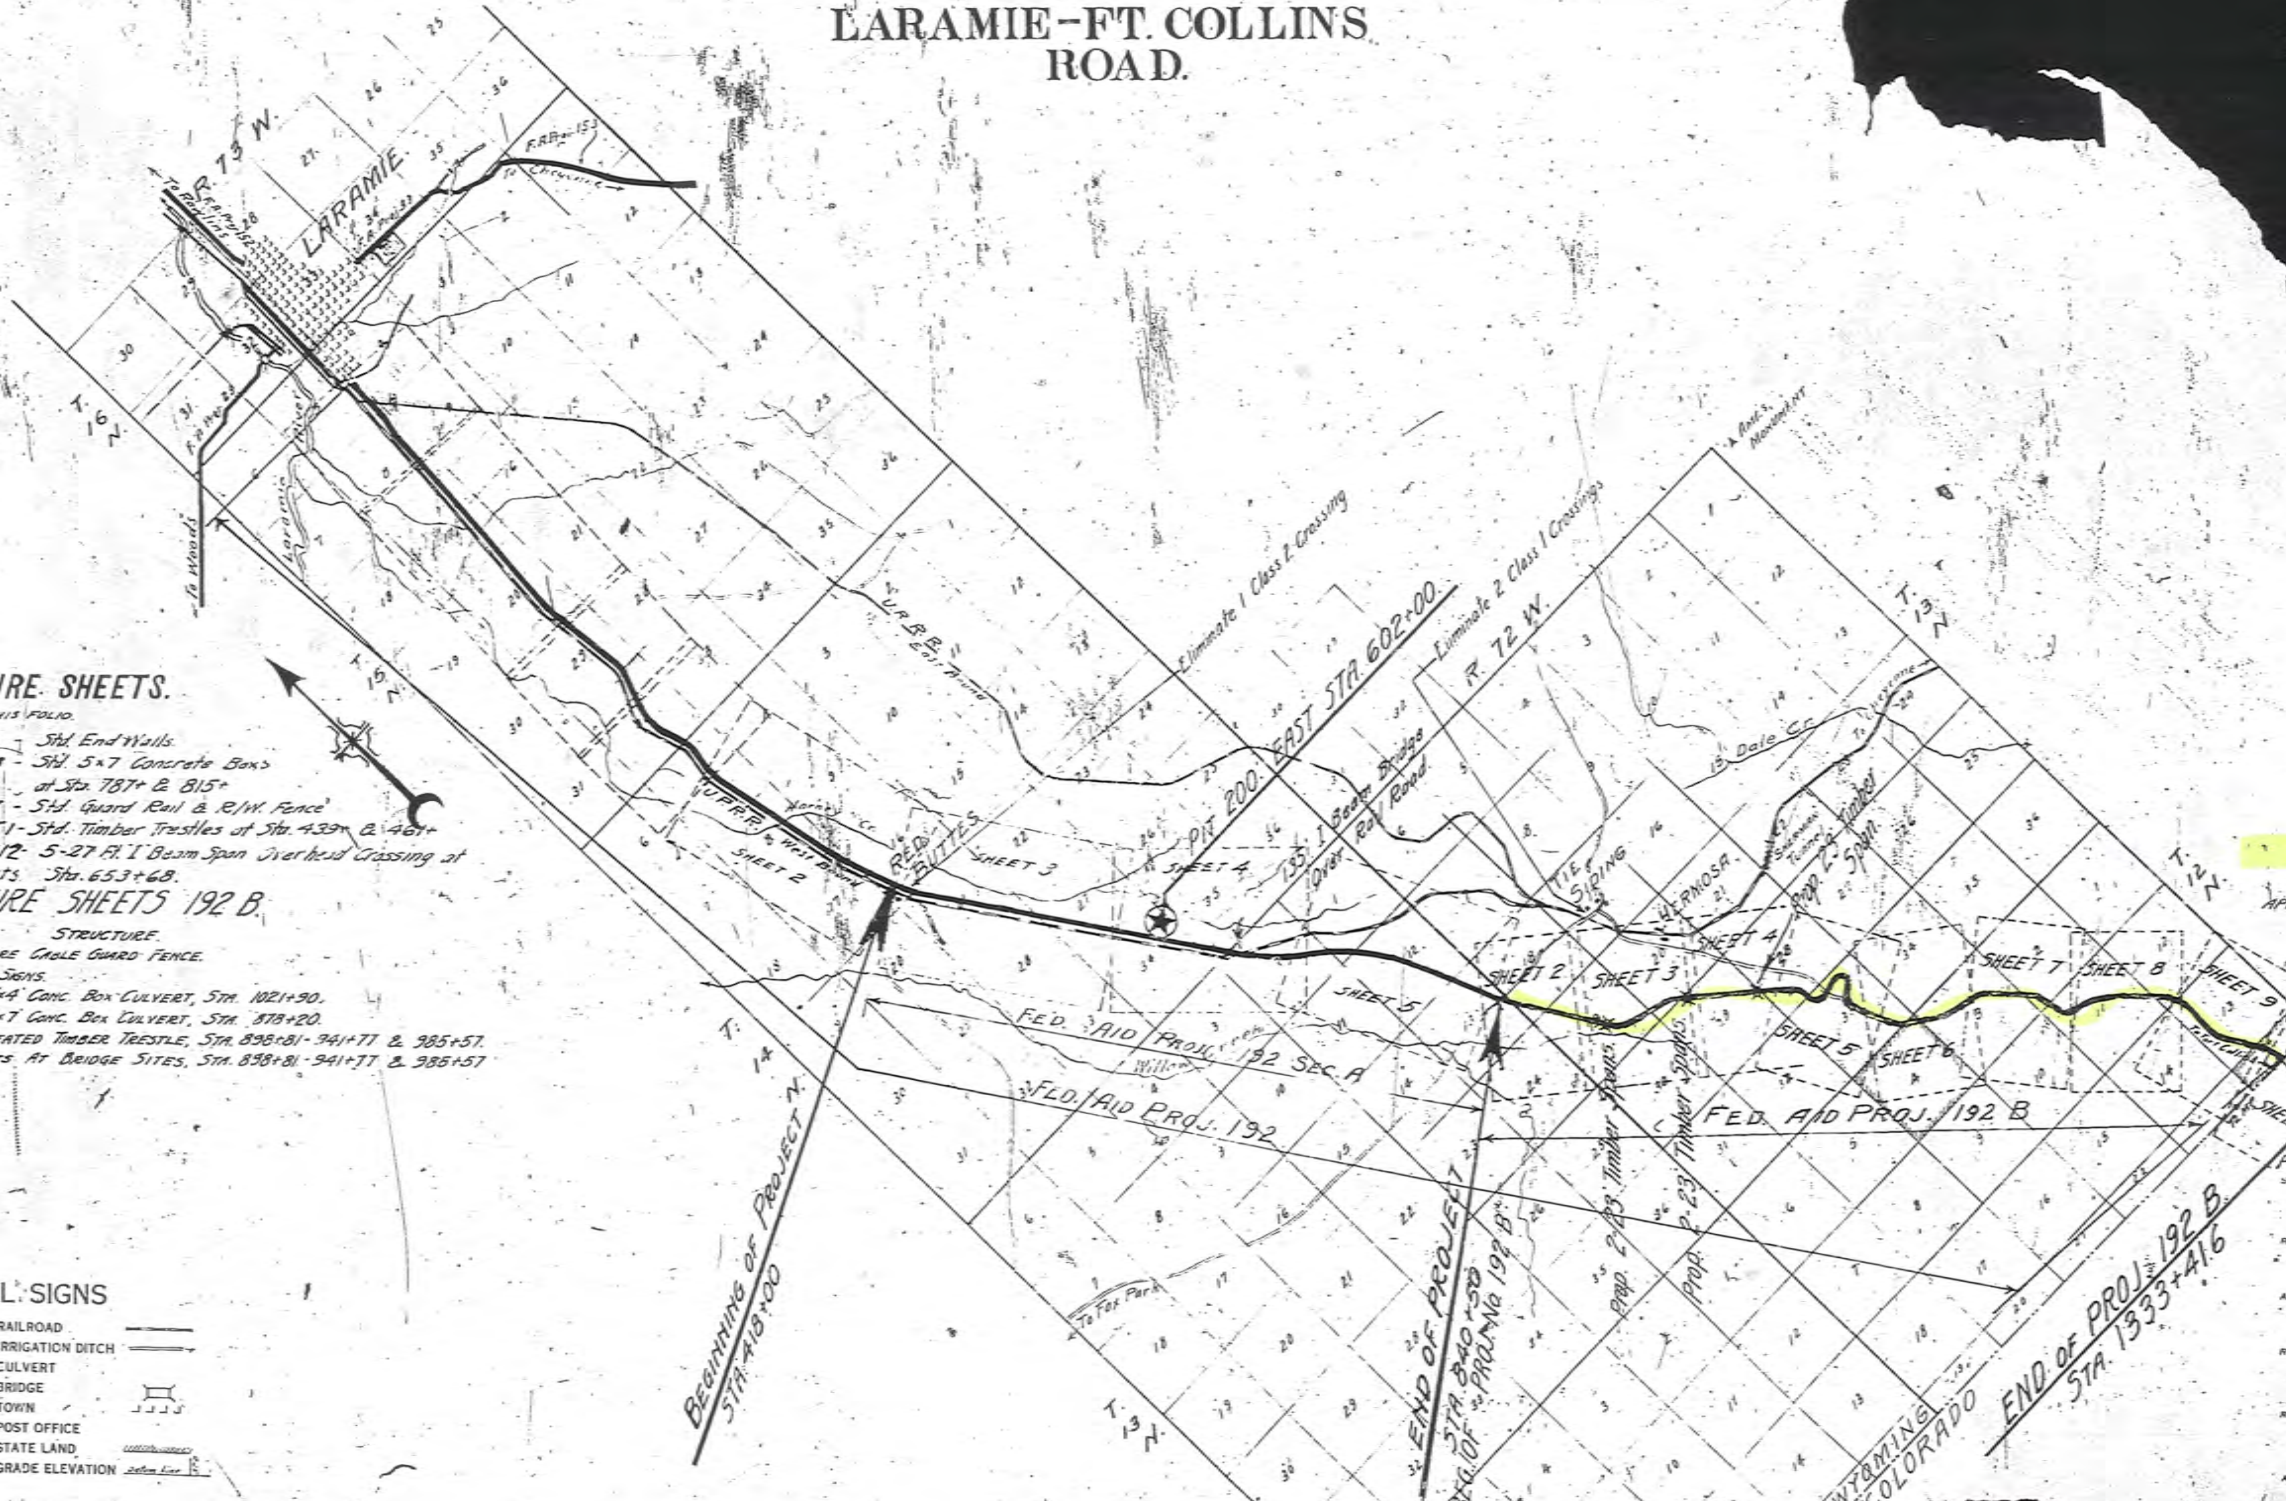

PROJECT 192 SEC. B.

APPROVED [Signature] Feb. STATE HIGHWAY SUPERINTENDENT

Proj. 192 Sec. A.

RECOMMENDED FOR APPROVAL

APPROVED [Signature]

RECOMMENDED FOR APPROVAL

DISTRICT ENGINEER

RECOMMENDED FOR APPROVAL

APPROVED [Signature]

DIRECTOR, BUREAU OF PUBLIC ROADS

12-3

PROJ. No. 192 A
INDEX OF SHEETS

SHEET NO.	TITLE PAGE
1	2B TYPICAL CROSS-SECTION OF ROADWAY
2	2C DETOUR SIGNS
3	PLAN AND PROFILE STA. 418+00 TO STA. 442+00
4	" " " " 441+00 " " 568+00
5	" " " " 567+00 " " 693+00
6	" " " " 693+00 " " 757+00
7	" " " " 756+00 " " 833+00
8	" " " " 833+00 " " 848+50
7-27	Cross-Sections, STA. 418+00 to 848+50

PROJ. No. 192 B

SHEET NO.	TITLE PAGE
2A	TYPICAL SECTIONS OF ROADWAY
2B	DETOUR SIGNS - INCIDENTAL SMALL STREET
2C	SUMMARY SHEET
2	PLAN AND PROFILE STA. 840+50 TO 883
3	" " " " 882 " 946
4	" " " " 945 " 1009
5	" " " " 1008 " 1072
6	" " " " 1071 " 1135
7	" " " " 1134 " 1198
8	" " " " 1197 " 1261
9	" " " " 1260 " 1324
10	" " " " 1322 " 1333+41.6
11 to 57	Cross-Sections

STATE OF WYOMING
STATE HIGHWAY DEPARTMENT
PLAN AND PROFILE OF PROPOSED
STATE HIGHWAY
FEDERAL AID PROJECT
ALBANY COUNTY
LARAMIE - FT. COLLINS
ROAD.

NOTE - SPECI...

SCALE	1" = 400'
VERTICAL SCALE	1" = 20'
PROJ. NO.	192
SECTION	B

INDEX OF STRUCTURE SHEETS

TO ACCOMPANY THIS FOLDER


SHEET NO.	DRAWING NO.	DESCRIPTION
1	3750.5	Std. End Walls
2	4018C	Std. 5x7 Concrete Box at Sta. 787+8.815
3	3833.7	Std. Guard Rail & 12" W. Fence
4	433PT1	Std. Timber Trestles at Sta. 439+8 & 441+8
5	433B12	5x7 P.T. Beam Span Overhead Crossing at 2 Sheets Sta. 453+68

INDEX OF STRUCTURE SHEETS 192 B

SHEET NO.	DESCRIPTION	STRUCTURE
1	3633.8	Std. Wire Cable Guard Fence
2B	7A 3721H	Detour Signs
3	4018C.B.4.9	Std. 4x4 Conc. Box Culvert, Sta. 1021+90
4	5-102	Std. 5x7 Conc. Box Culvert, Sta. 878+00
5	5-102	Std. Treated Timber Trestle, Sta. 896+81-941+77 & 985+57
6	89/1096	Profiles At Bridge Sites, Sta. 890+81-941+77 & 985+57

CONVENTIONAL SIGNS

TOWNSHIP LINE	RAILROAD
SECTION LINE	IRRIGATION DITCH
INTERIOR SEC. LINE	CULVERT
FENCE LINE	BRIDGE
POLE LINE	TOWN
RIGHT OF WAY	POST OFFICE
SURVEY LINE	STATE LAND
TRAVELED WAY	GRADE ELEVATION

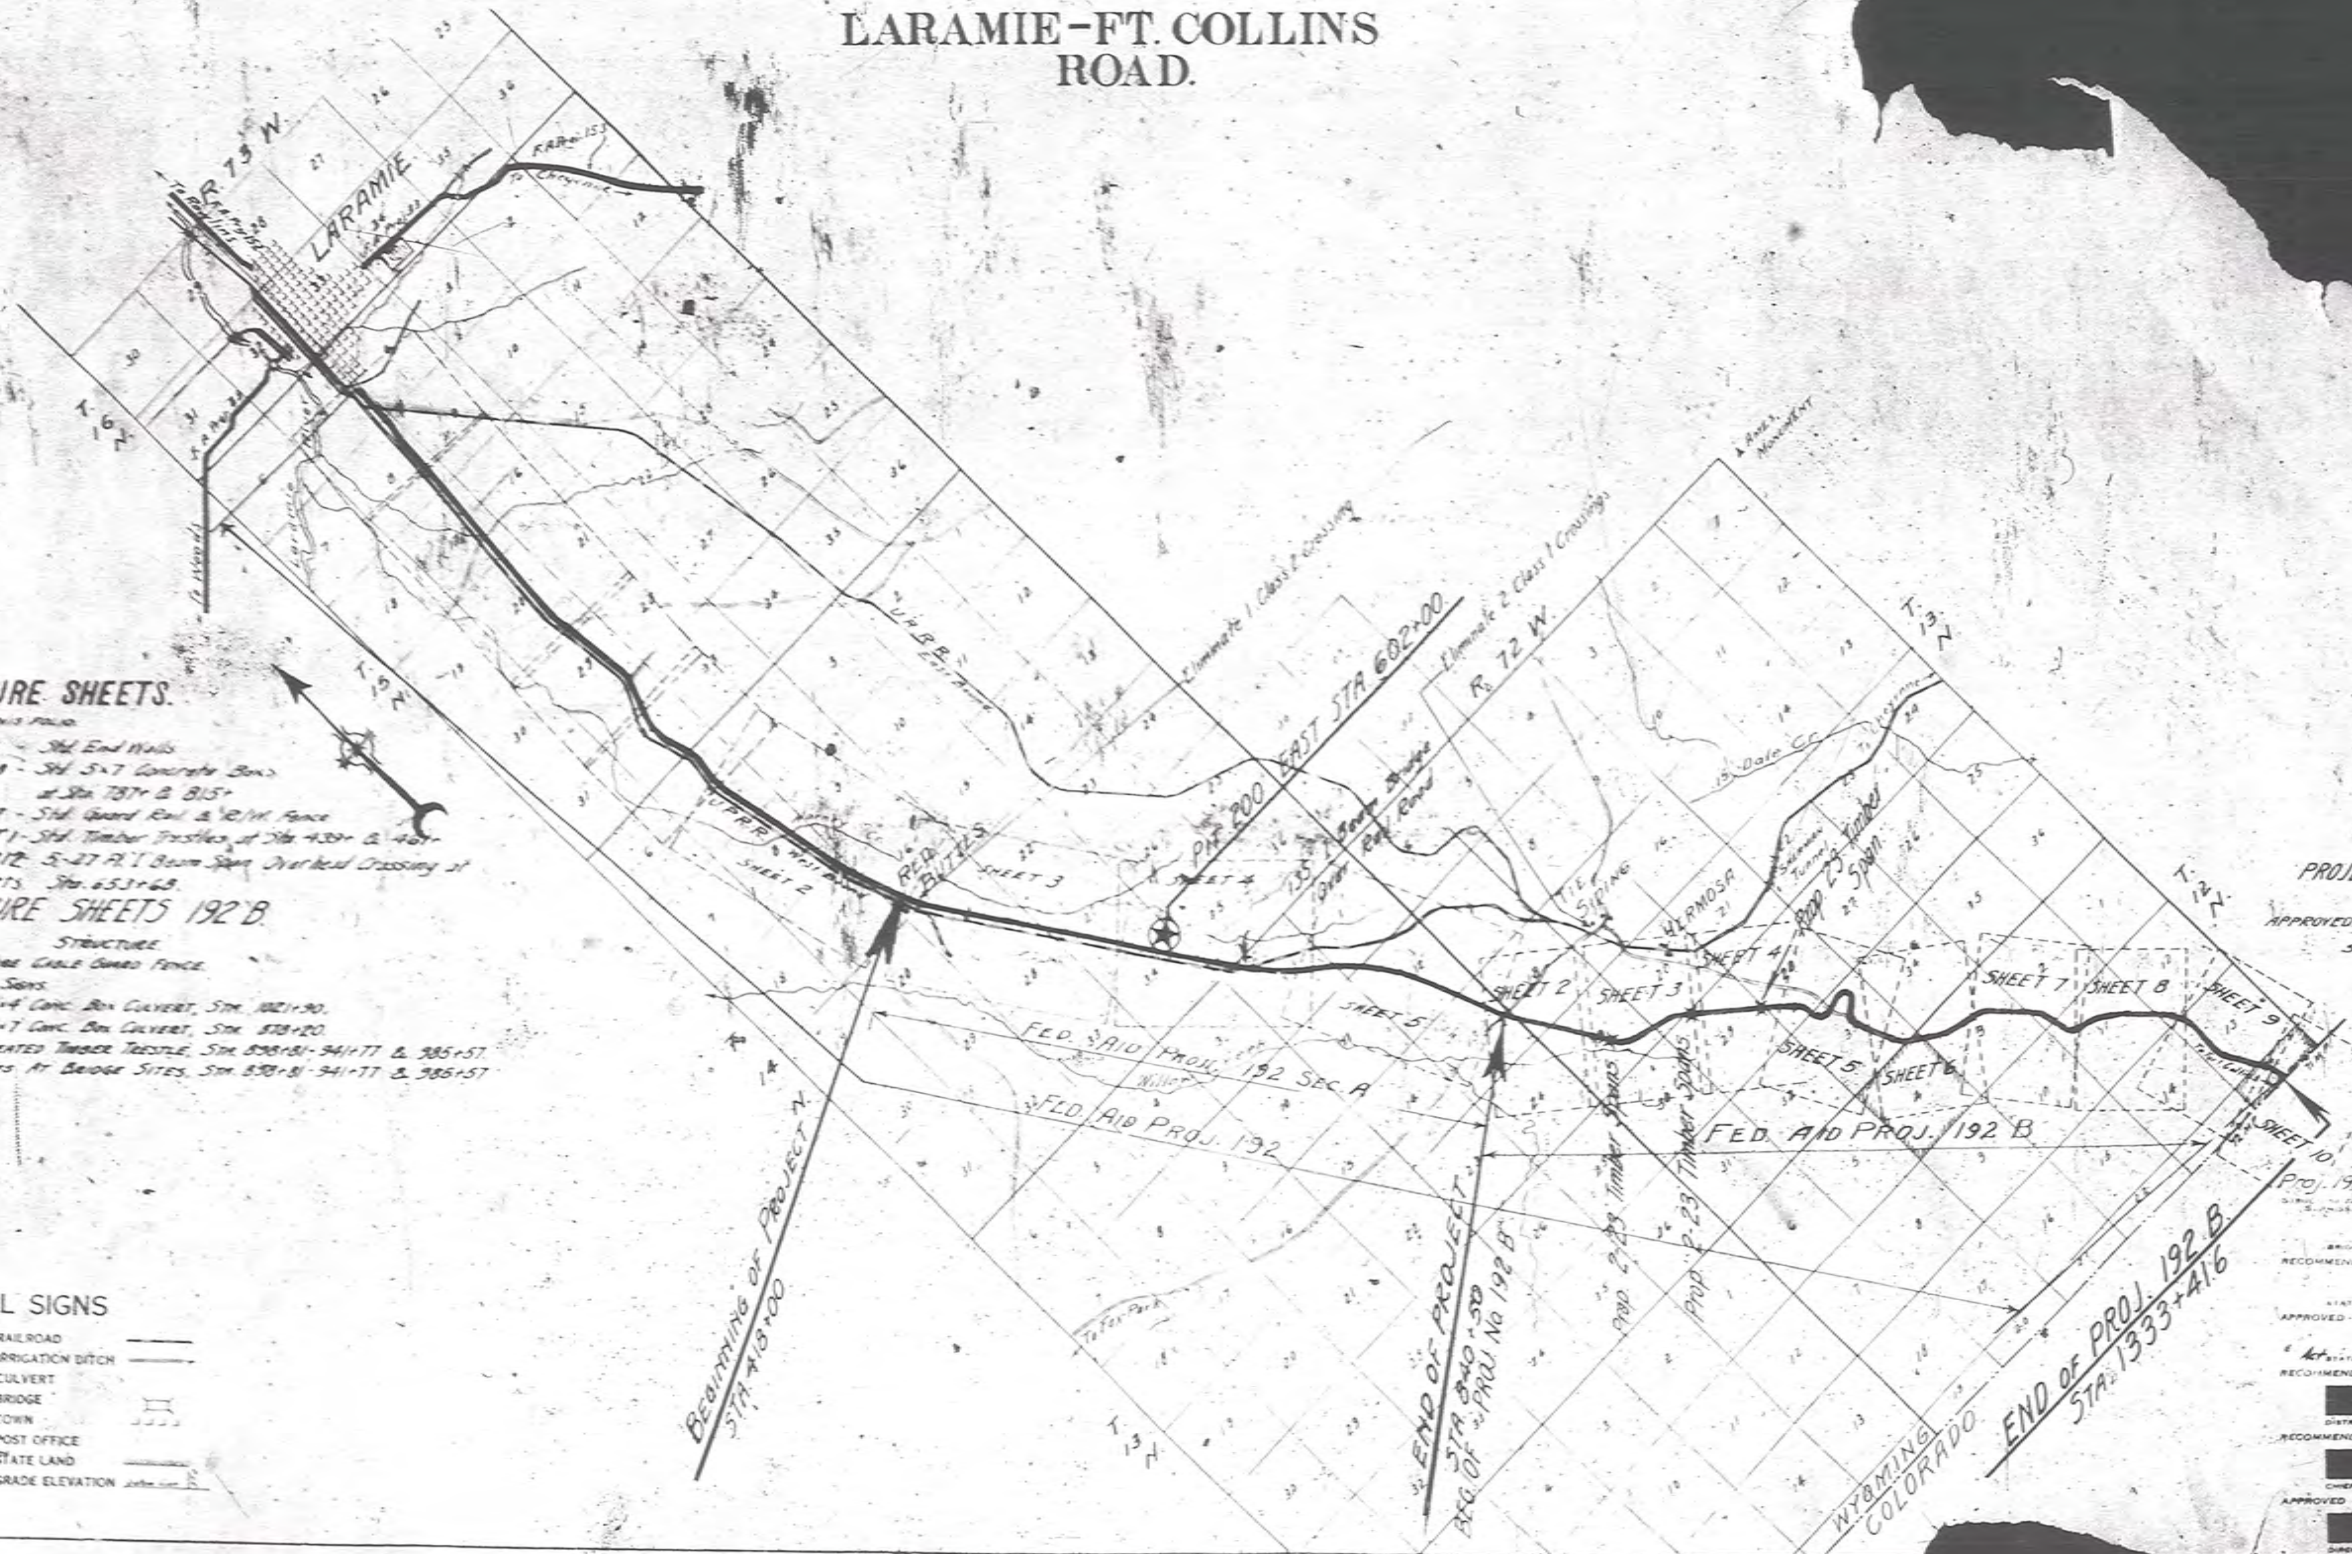

PROJECT 192 SEC. B
APPROVED: [Signature]
STATE HIGHWAY SUPERINTENDENT

PROJECT 192 SEC. A
APPROVED: [Signature]
STATE HIGHWAY SUPERINTENDENT

BRIDGE ENGINEER
RECOMMENDED FOR APPROVAL

DISTRICT ENGINEER
RECOMMENDED FOR APPROVAL

CHIEF ENGINEER
RECOMMENDED FOR APPROVAL

DIRECTOR, BUREAU OF PUBLIC ROADS



WYOMING
COLORADO

END OF PROJ. 192 B
STA. 1333+41.6

END OF PROJECT
STA. 840+50
BEG. OF PROJ. NO. 192 B


BEGINNING OF PROJECT
STA. 418+00

A. H. HAWKS

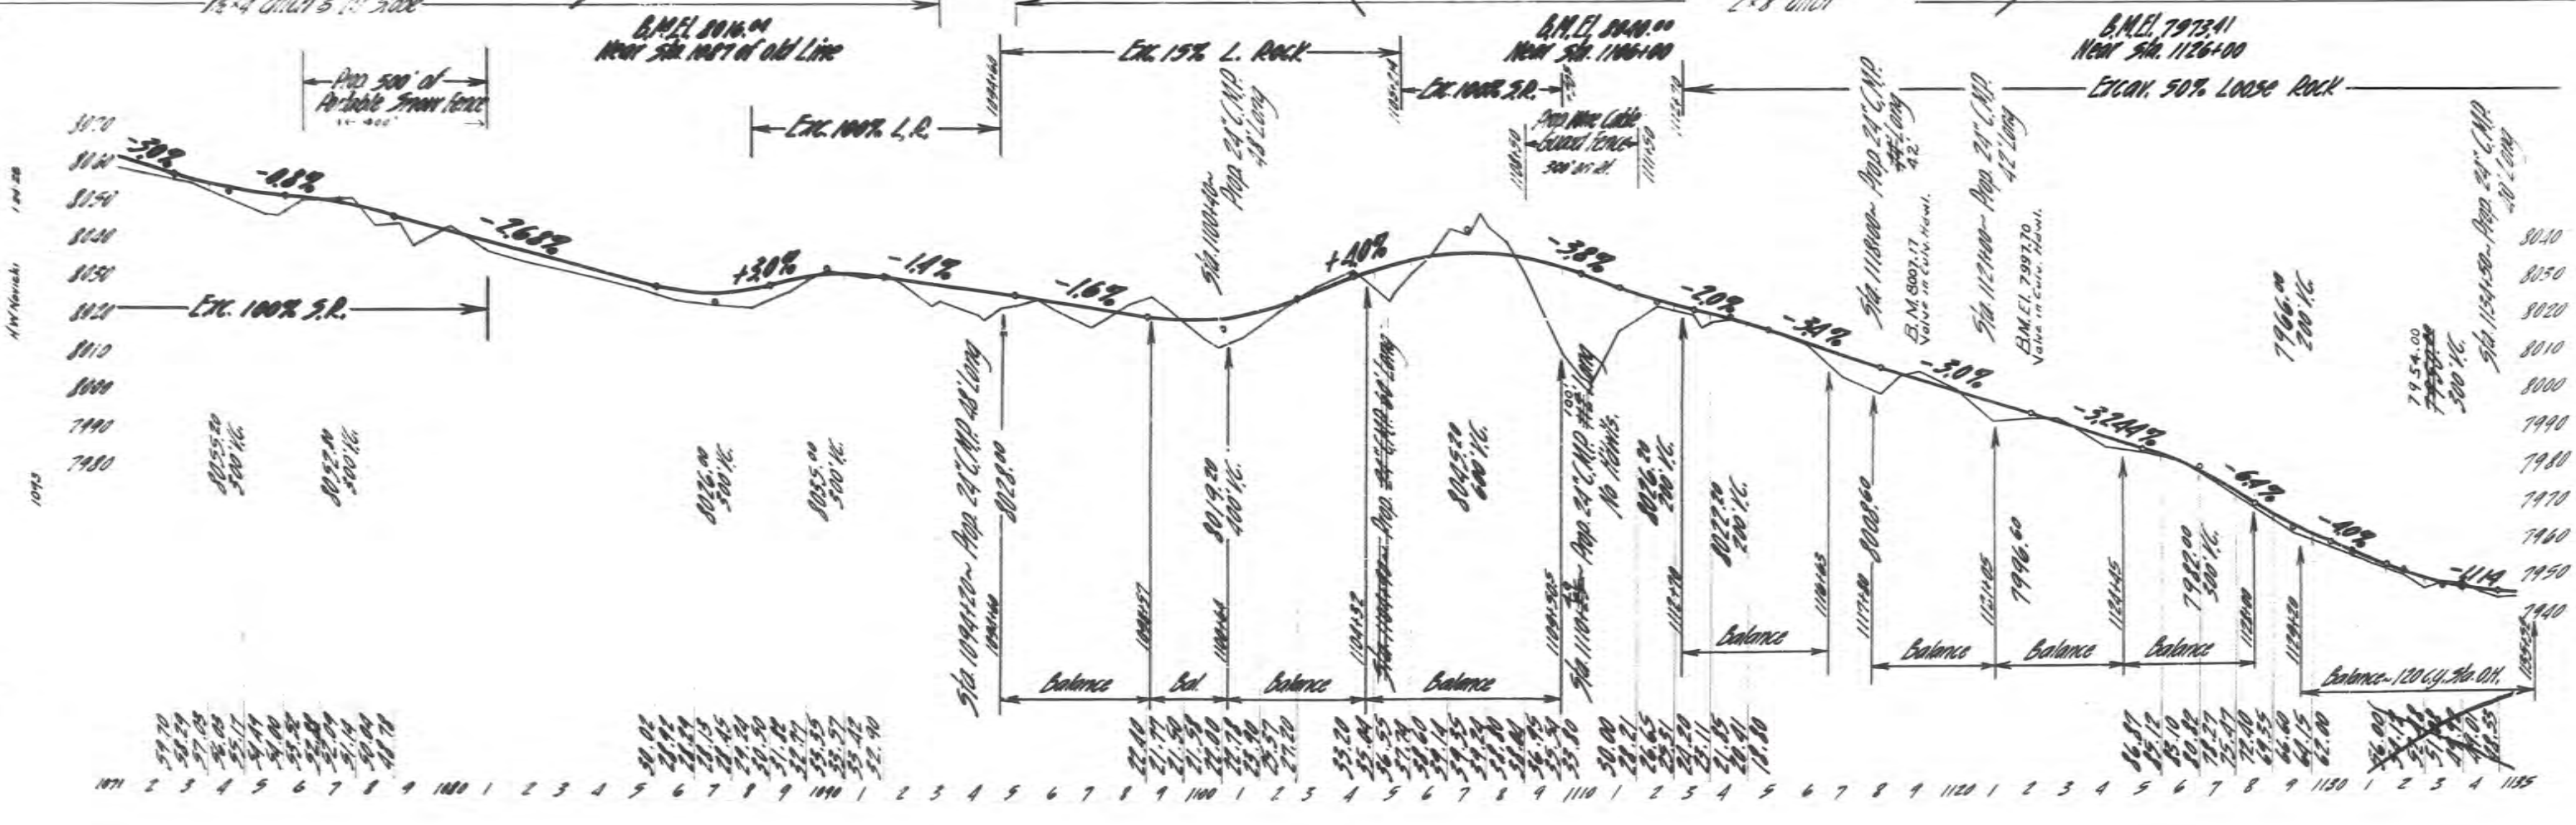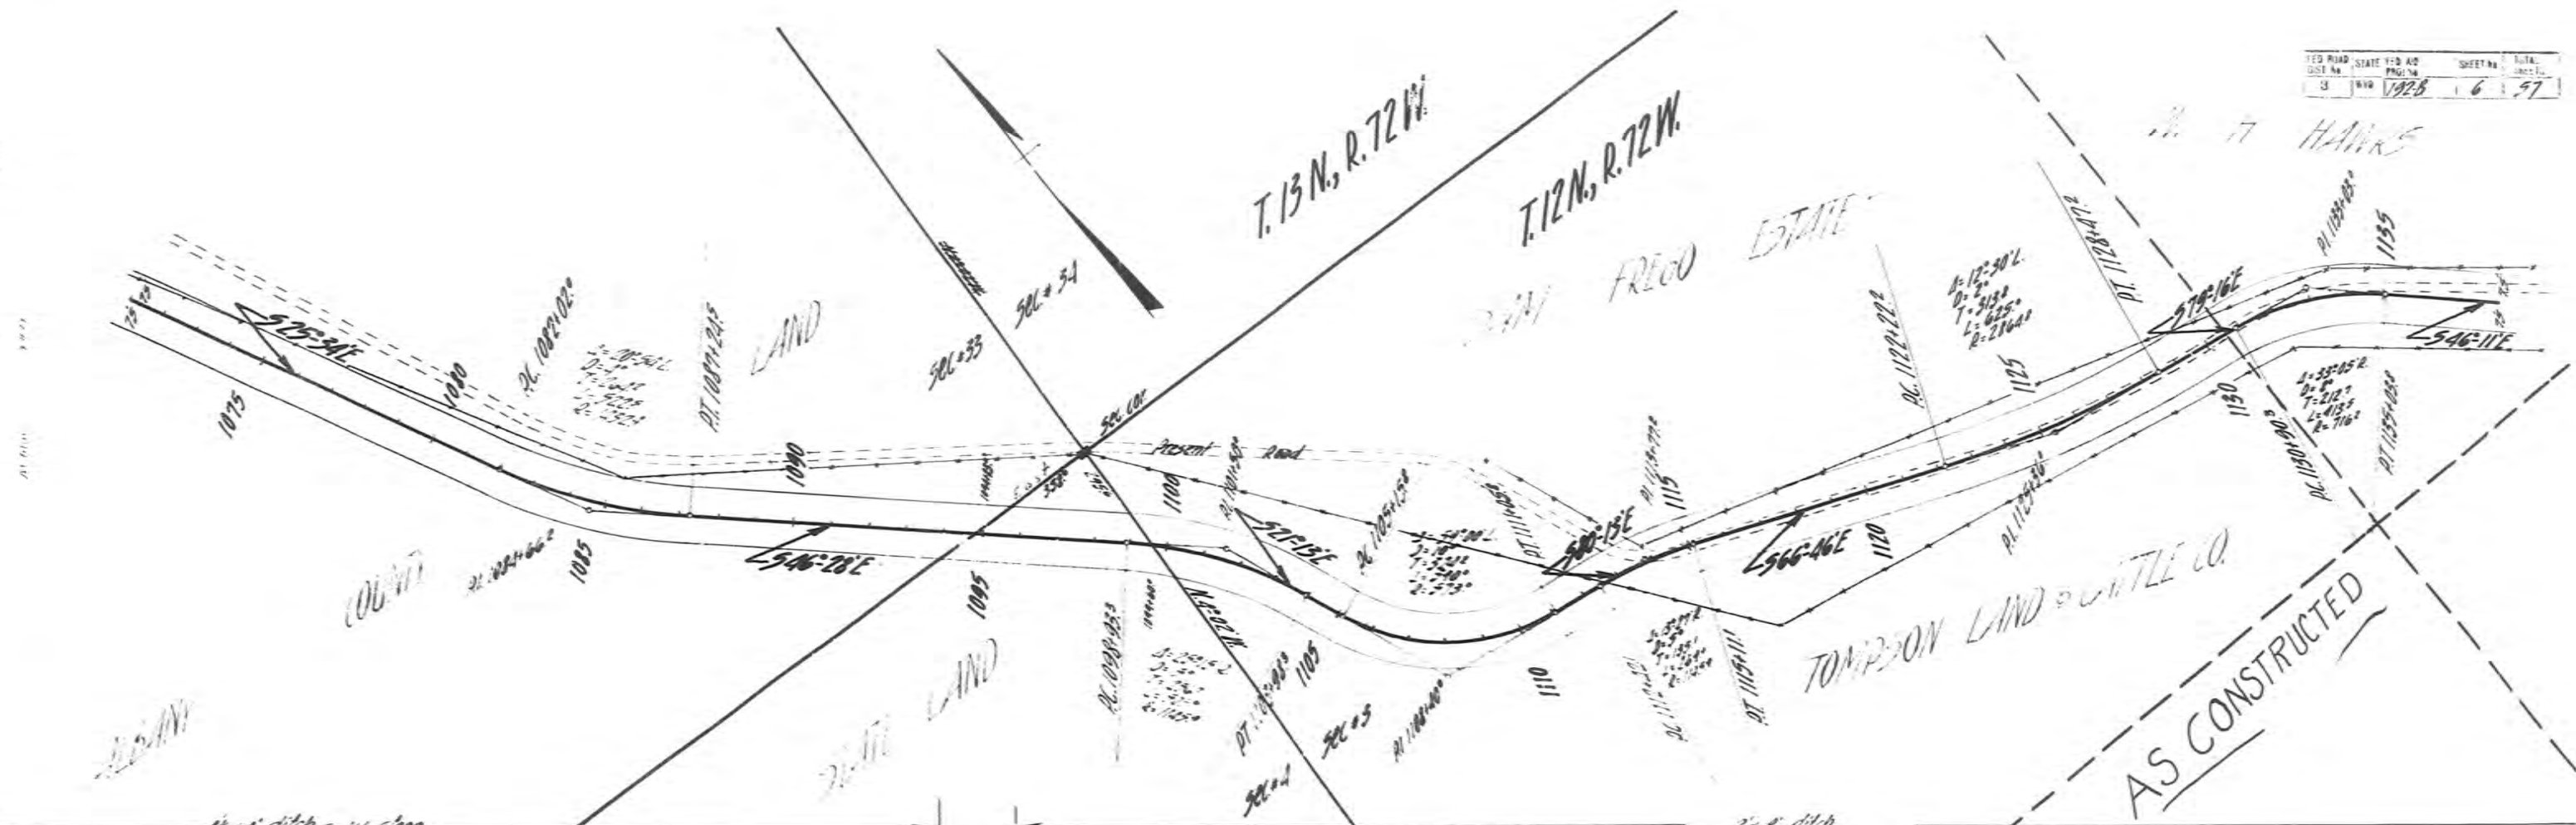


H.W. Nichols 1 and 28 1915

79.70	80.02	80.26	80.55	80.77	80.99	294.17	
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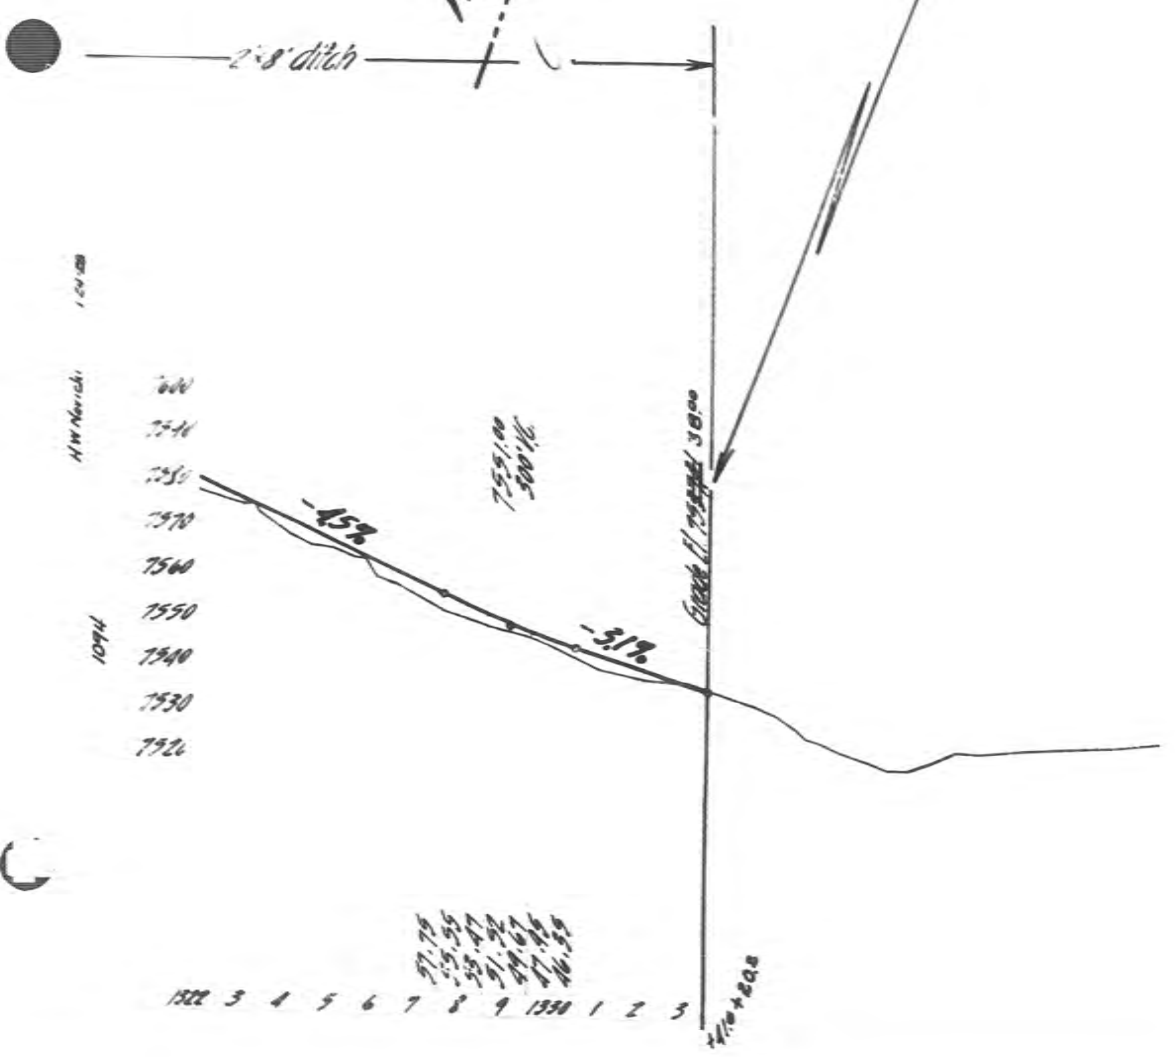
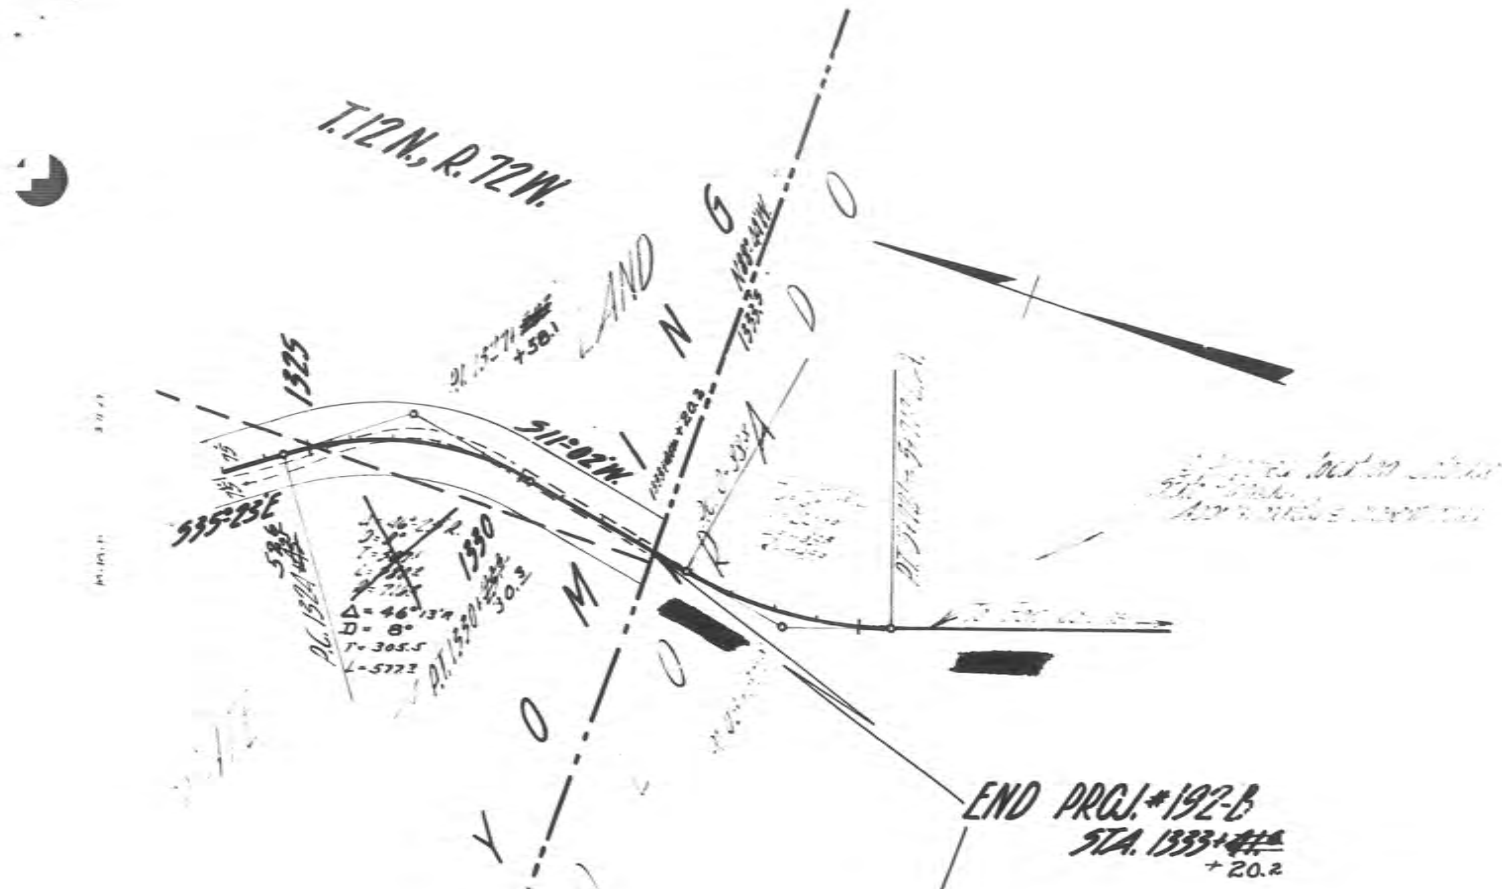


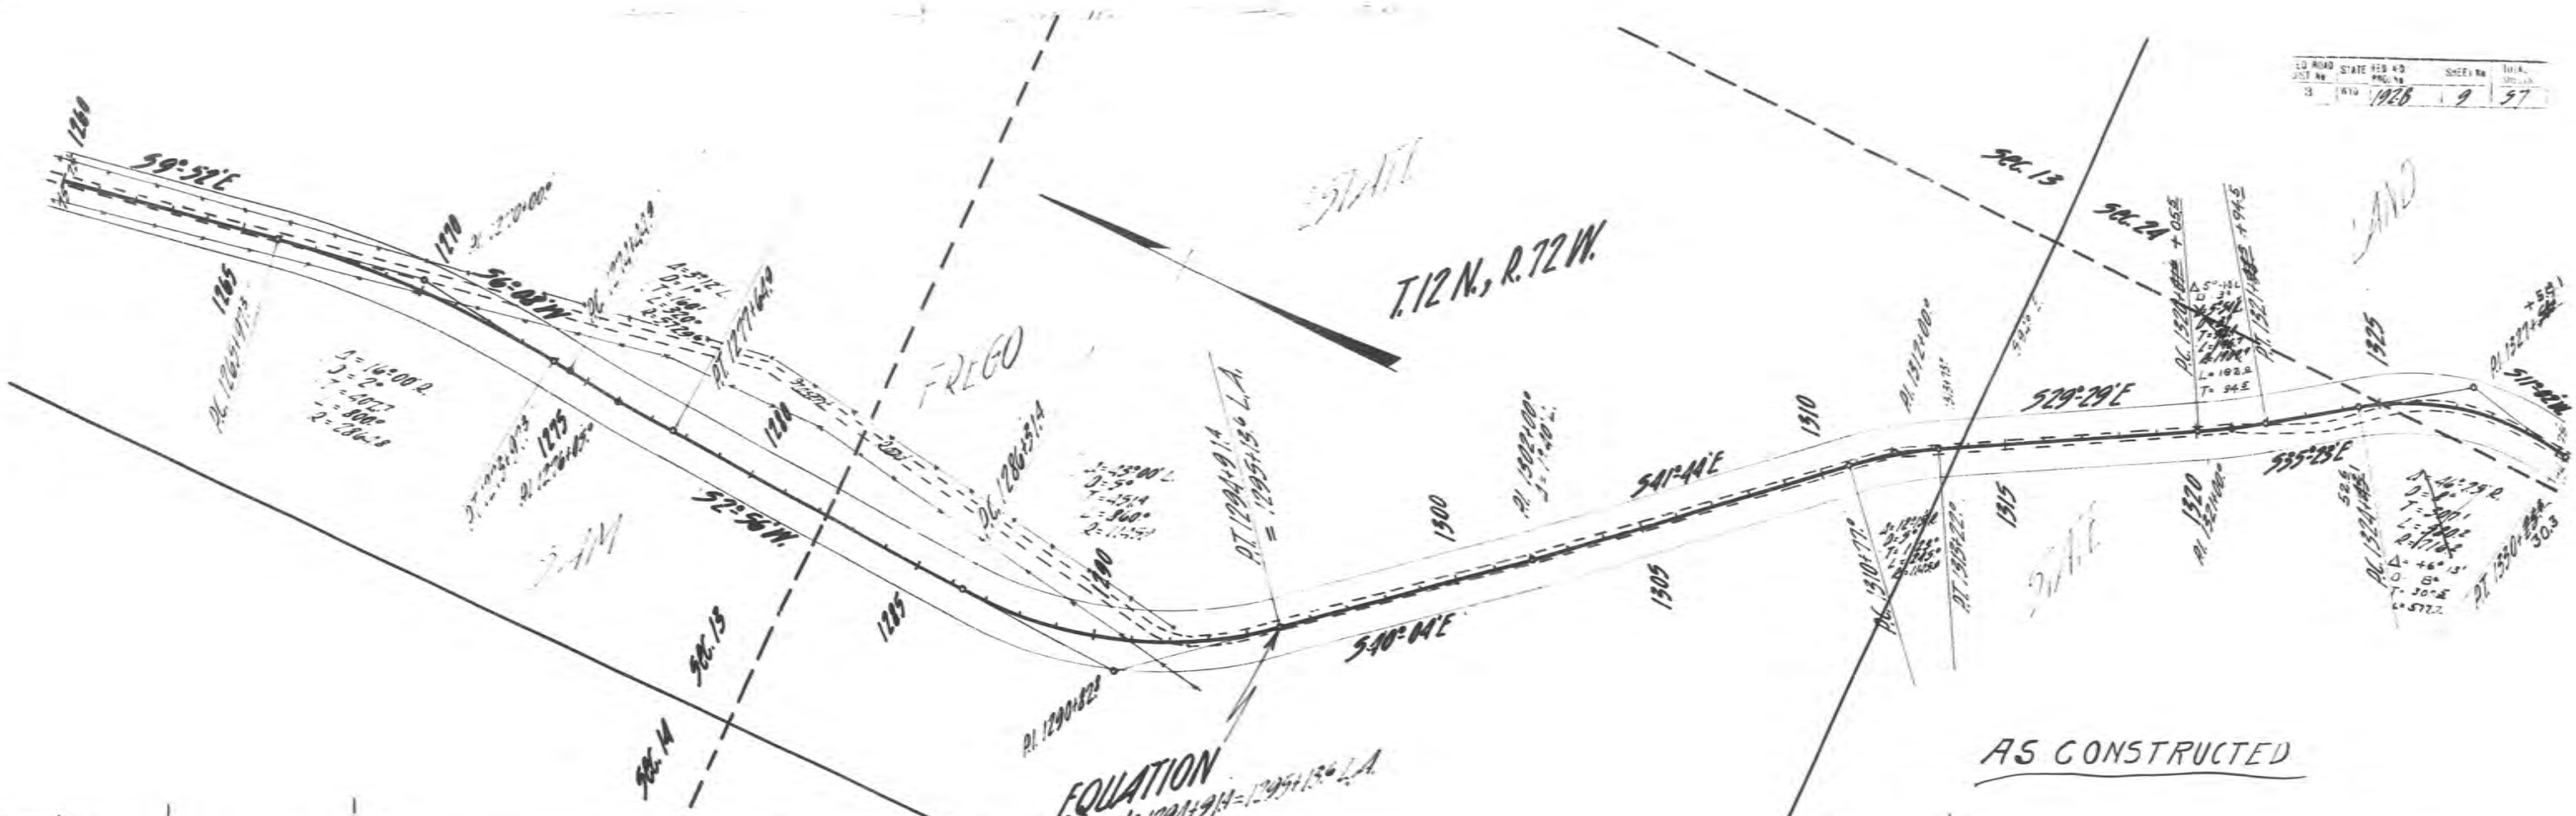EQUATION
 $50(1290 + 914) = 1295(1300)$

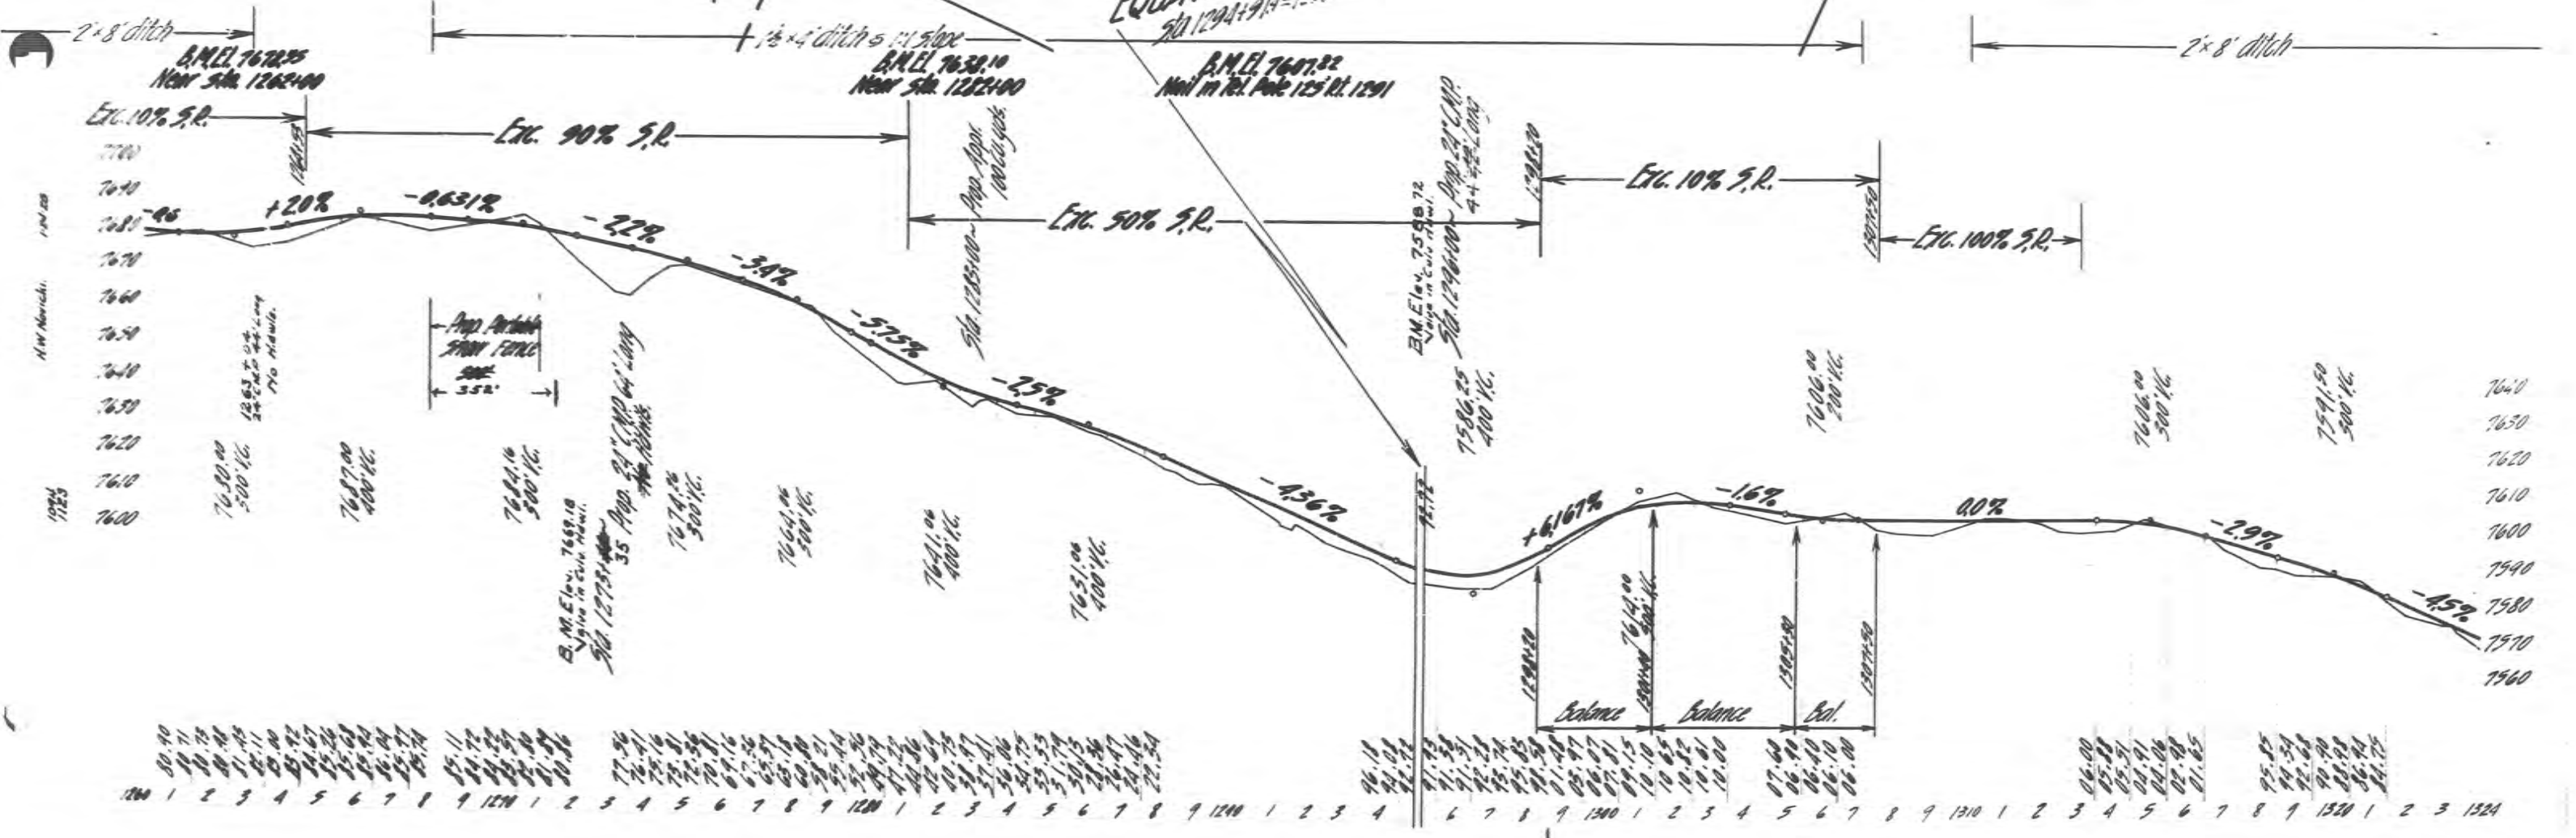

80.90	81.71	82.52	489.14	490.95	491.76	492.57	639.18	640.99	641.80	642.61	849.16	850.97	851.78	852.59	955.46	956.
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T. 12N, R. 72W



As Constructed